

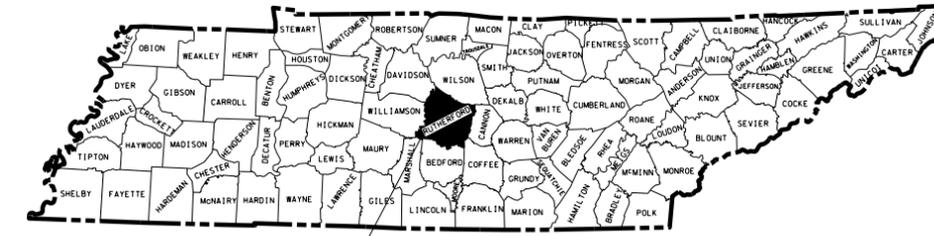
Index Of Sheets
SEE SHEET IA

STATE OF TENNESSEE DEPARTMENT OF TRANSPORTATION BUREAU OF ENGINEERING

TENN.	YEAR	SHEET NO.
	2014	1
FED. AID PROJ. NO.	PHSIP/NH-SIP-96(36)	
STATE PROJ. NO.	75009-3236-94	

RUTHERFORD COUNTY STATE ROUTE 96 INTERSECTION WITH MARKET PLACE IN MURFREESBORO CONSTRUCTION

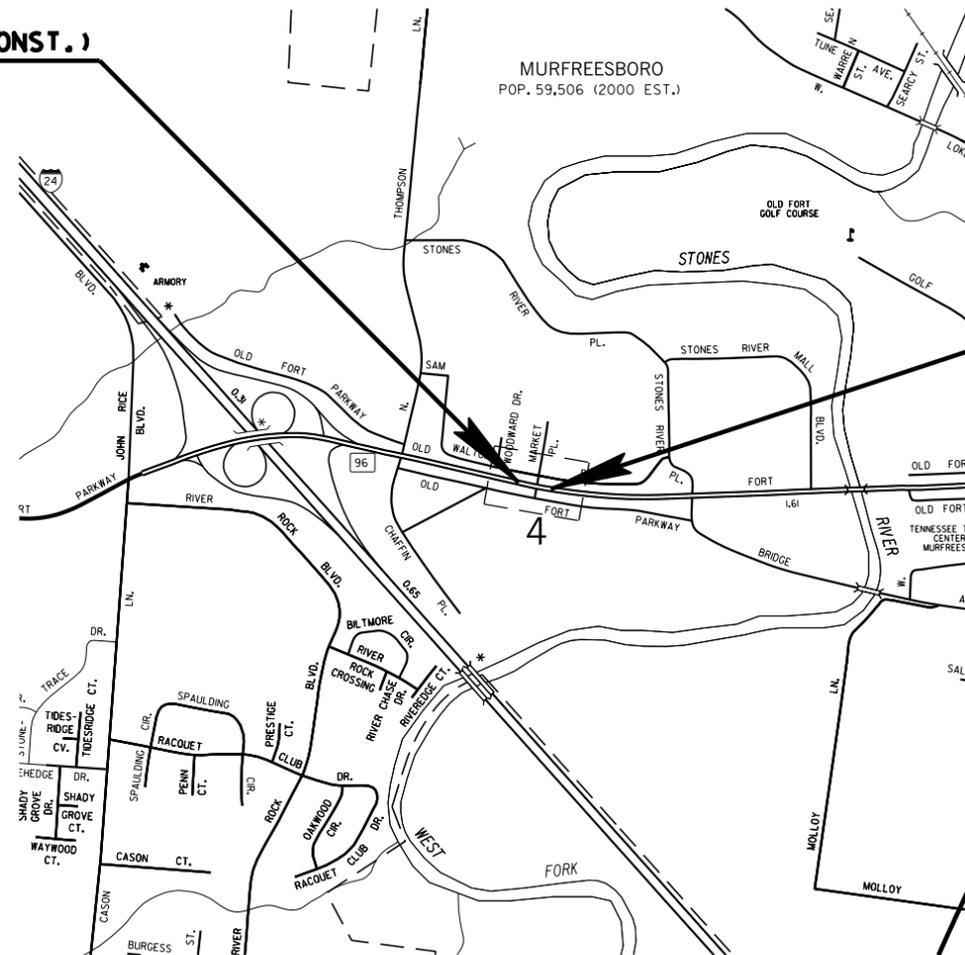
STATE HIGHWAY NO. 96 F.A.H.S. NO. NA



PROJECT LOCATION

75009-3236-94
BEGIN PROJECT PHSIP/NH-SIP-96(36) (CONST.)
STATION 520+00.00

NO RIGHT-OF-WAY REQUIRED



SCALE: 1" = 1000 FEET

NO EXCLUSIONS
NO EQUATIONS

**UNOFFICIAL
SET
NOT FOR
BIDDING**

75009-3236-94
END PROJECT PHSIP/NH-SIP-96(36) (CONST.)
STATION 531+50.00

SURVEY DATE: 6-27-13

SPECIAL NOTES

PROPOSALS MAY BE REJECTED BY THE COMMISSIONER IF ANY OF THE UNIT PRICES CONTAINED THEREIN ARE OBVIOUSLY UNBALANCED, EITHER EXCESSIVE OR BELOW THE REASONABLE COST ANALYSIS VALUE.

THIS PROJECT TO BE CONSTRUCTED UNDER THE STANDARD SPECIFICATIONS OF THE TENNESSEE DEPARTMENT OF TRANSPORTATION DATED MARCH 1, 2006 AND ADDITIONAL SPECIFICATIONS AND SPECIAL PROVISIONS CONTAINED IN THE PLANS AND IN THE PROPOSAL CONTRACT.

TDOT ROAD SP. SV. 2 BILLY BINION
DESIGNER SCOTT JOHNSON CHECKED BY DARRELL GRAY
P.E. NO. 75009-1236-94
PIN NO. 118436.00

PROJECT LENGTH 0.217 MILES
NO RIGHT OF WAY REQUIRED

TRAFFIC DATA	
ADT (2014)	35010
ADT (2034)	42850
DHV (2034)	4279
D	50 - 50
T (ADT)	2 %
T (DHV)	1 %
V	40 MPH

SEALED BY

APPROVED: Paul D. Degges
PAUL D. DEGGES, CHIEF ENGINEER

DATE: _____
APPROVED: John Schroer
JOHN SCHROER, COMMISSIONER

U.S. DEPARTMENT OF TRANSPORTATION
FEDERAL HIGHWAY ADMINISTRATION

APPROVED: _____
DIVISION ADMINISTRATOR DATE

D6-AUG-2014 16:01 \\J03WF01\dot.state.tn.us\03Shared\SURVEY\DESIGN\PIN 118436.00 Rutherford Co SR-96 & Market Place RSAR\001-Construction\Title.sht

TYPE	YEAR	PROJECT NO.	SHEET NO.
CONST.	2014	PHSIP/NH-SIP-96(36)	1A

INDEX

STANDARD ROADWAY DRAWINGS

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TITLE SHEET	1
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NO PROJECT COMMITMENTS SHEET INCLUDED IN THIS SET OF PLANS	

DWG. NO	REV.	DESCRIPTION
ROADWAY DESIGN STANDARDS		
RD-A-1	12-18-99	STANDARD ABBREVIATIONS
RD-L-1	10-26-94	STANDARD LEGEND
RD-L-2	09-05-01	STANDARD LEGEND FOR UTILITY INSTALLATIONS
RD-L-3	04-15-04	STANDARD LEGEND FOR SIGNALIZATION AND LIGHTING
RD-L-4	04-15-04	STANDARD LEGEND FOR SIGNALIZATION AND LIGHTING
RD-L-5	05-01-08	STANDARD LEGEND FOR EROSION PREVENTION AND SEDIMENT CONTROL
RD-L-6	03-30-10	STANDARD LEGEND FOR EROSION PREVENTION AND SEDIMENT CONTROL
RD-L-7	05-24-12	STANDARD LEGEND FOR EROSION PREVENTION AND SEDIMENT CONTROL
RD01-TS-3A	10-15-02	DESIGN STANDARDS 4 AND 6 LANE ARTERIAL HIGHWAYS WITH DEPRESSED MEDIANS
RD01-TS-3C	10-15-02	DESIGN STANDARDS 4 AND 6 LANE ARTERIAL HIGHWAYS WITH FLUSH MEDIANS
DRAINAGE - CULVERTS AND ENDWALL		
D-PB-1	01-02-13	STANDARD DETAILS CLASS "B" BEDDING AND CULVERT EXCAVATION
D-PB-2	01-29-14	STANDARD DETAILS FOR PLASTIC PIPE INSTALLATION
DRAINAGE-CATCH BASINS AND MANHOLES		
D-CB-42RB	03-11-14	STANDARD PRECAST CIRCULAR NO. 42 CATCH BASIN
D-CB-42S	08-01-12	STANDARD 32" X 32" SQUARE CONCRETE NO. 42 CATCH BASIN
D-CB-42SB	03-11-14	STANDARD 4' X 4' SQUARE CONCRETE NO. 42 CATCH BASIN
D-CB-42SC	03-11-14	STANDARD 5'2" X 5'2" SQUARE CONCRETE NO. 42 CATCH BASIN
D-CB-42SD	03-11-14	STANDARD 7' X 7' SQUARE CONCRETE NO. 42 CATCH BASIN
D-CBB-42	05-27-01	CAST IRON GRATE DETAILS FOR NOS. 42, 43 & 44 TYPE CATCH BASINS
ROADWAY AND PAVEMENT APPURTENANCES		
RP-H-6	06-14-13	MEDIAN CROSSING
RP-NMC-10	07-29-03	STANDARD VERTICAL (NONMOUNTABLE) CONCRETE CURBS AND CONCRETE CURBS AND GUTTERS
RP-NMC-11	02-28-02	STANDARD VERTICAL (NONMOUNTABLE) CONCRETE CURBS AND CONCRETE CURBS AND GUTTERS
TRAFFIC CONTROL APPURTENANCES		
T-FAB-1	05-27-97	FLASHING YELLOW ARROW BOARD
T-M-1	11-01-11	DETAILS OF PAVEMENT MARKINGS FOR CONVENTIONAL ROADS AND MARKING ABBREVIATIONS
T-M-2	01-15-13	DETAILS OF PAVEMENT MARKINGS FOR CONVENTIONAL ROADS
T-M-3	09-19-91	MARKING STANDARDS FOR TRAFFIC ISLANDS, MEDIANS & PAVED SHOULDERS ON CONVENTIONAL ROADS
T-M-4	11-01-11	STANDARD INTERSECTION PAVEMENT MARKINGS
T-M-16	11-01-11	ASPHALT SHOULDER RUMBLE STRIPE INSTALLATION DETAILS FOR NON-ACCESS CONTROLLED ROUTES

DWG. NO	REV.	DESCRIPTION
T-PBR-1	06-30-09	INTERCONNECTED PORTABLE BARRIER RAIL
T-PBR-2	10-10-06	DETAIL FOR VERTICAL PANELS AND FLEXIBLE DELINEATORS
T-S-9	11-01-11	STANDARD LAYOUT GROUND MOUNTED SIGNS
T-S-16	11-01-11	GROUND MOUNTED ROADSIDE SIGN AND DETAILS
T-S-20	11-01-11	SIGN DETAILS
T-S-21	02-28-13	DETAILS FOR SIGNS MOUNTS ON CONCRETE MEDIAN BARRIERS
T-SG-2	07-29-04	LOOP LEAD-INS, CONDUIT AND PULL BOXES
T-SG-3	11-11-04	STANDARD NOTES AND DETAILS OF INDUCTIVE LOOPS
T-SG-7A	11-01-11	TYPICAL SIGNAL HEAD PLACEMENT
T-SG-8	12-04-13	STRAIN POLE DETAILS FOR SPAN MOUNTED SIGNALS
T-SG-11	07-29-04	MAINTENANCE OF EXISTING SIGNALS DURING HIGHWAY CONSTRUCTION
T-WZ-10	04-02-12	ADVANCE ROAD WORK SIGNING ON HIGHWAYS AND FREEWAYS
T-WZ-11	03-13-09	ONE LANE CLOSURE DETAIL ON DIVIDED HIGHWAYS
EROSION PREVENTION AND SEDIMENT CONTROL		
EC-STR-3B	08-01-12	SILT FENCE
EC-STR-8	08-01-12	FILTER SOCK
EC-STR-19	04-01-08	CATCH BASIN PROTECTION
EC-STR-25	08-01-12	TEMPORARY CULVERT CROSSING, CONSTRUCTION EXIT, CONSTRUCTION FORD

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DEPARTMENT OF TRANSPORTATION

INDEX
AND
STANDARD
DRAWINGS

TYPE	YEAR	PROJECT NO.	SHEET NO.
CONST.	2014	PHSIP/NH-SIP-96(36)	2

ESTIMATED ROADWAY QUANTITIES			
ITEM NO.	DESCRIPTION	UNIT	QUANTITY
105-01	CONSTRUCTION STAKES, LINES AND GRADES	LS	1
202-03.02	REMOVAL OF RIGID PAVEMENT	C.Y.	305
203-01	ROAD & DRAINAGE EXCAVATION (UNCLASSIFIED)	C.Y.	1340
209-03.20	FILTER SOCK (8 INCH)	L.F.	100
209-08.03	TEMPORARY SILT FENCE (WITHOUT BACKING)	L.F.	700
209-40.33	CATCH BASIN PROTECTION (TYPE D)	EACH	2
303-01	MINERAL AGGREGATE, TYPE A BASE, GRADING D	TON	1120
307-02.01	ASPHALT CONCRETE MIX (PG70-22) (BPMB-HM) GRADING A	TON	460
307-02.08	ASPHALT CONCRETE MIX (PG70-22) (BPMB-HM) GRADING B-M2	TON	225
402-01	BITUMINOUS MATERIAL FOR PRIME COAT (PC)	TON	3
402-02	AGGREGATE FOR COVER MATERIAL (PC)	TON	12
403-01	BITUMINOUS MATERIAL FOR TACK COAT (TC)	TON	8
411-02.10	ACS MIX(PG70-22) GRADING D	TON	960
411-12.03	SCORING FOR RUMBLE STRIPE (NON-CONTINUOUS) (8IN WIDTH)	L.M.	0.3
415-01.01	COLD PLANING BITUMINOUS PAVEMENT	TON	891
604-01.01	CLASS A CONCRETE (ROADWAY)	C.Y.	50
607-03.30	18" PIPE CULVERT	L.F.	173
611-09.03	CAPPING EXISTING CATCHBASIN	EACH	1
611-42.01	CATCH BASINS, TYPE 42, 0' - 4' DEPTH	EACH	1
702-01	CONCRETE CURB	C.Y.	120
705-08.51	PORTABLE IMPACT ATTENUATOR NCHRP350 TL-3	EACH	2
709-05.05	MACHINED RIP-RAP (CLASS A-3)	TON	100
712-01	TRAFFIC CONTROL	LS	1
712-02.02	INTERCONNECTED PORTABLE BARRIER RAIL	L.F.	2550
712-04.01	FLEXIBLE DRUMS (CHANNELIZING)	EACH	50
712-05.01	WARNING LIGHTS (TYPE A)	EACH	10
712-06	SIGNS (CONSTRUCTION)	S.F.	326
712-06.01	VERTICAL PANELS	S.F.	80
712-08.03	ARROW BOARD (TYPE C)	EACH	2
716-02.04	PLASTIC PAVEMENT MARKING(CHANNELIZATION STRIPING)	S.Y.	200
716-02.05	PLASTIC PAVEMENT MARKING (STOP LINE)	L.F.	200
716-02.06	PLASTIC PAVEMENT MARKING (TURN LANE ARROW)	EACH	8
716-03.01	PLASTIC WORD PAVEMENT MARKING (ONLY)	EACH	2
716-04.01	PLASTIC PAVEMENT MARKING (STRAIGHT-TURN ARROW)	EACH	4
716-04.03	PLASTIC PAVEMENT MARKING (4" DOTTED LINE)	L.F.	400
716-05.01	PAINTED PAVEMENT MARKING (4" LINE)	L.M.	2
716-05.06	PAINTED PAVEMENT MARKING (TURN LANE ARROW)	EACH	18
716-12.02	ENHANCED FLATLINE THERMO PVM T MRKNG (6IN LINE)	L.M.	2
717-01	MOBILIZATION	LS	1
730-01.01	REMOVE & RELOCATE EXISTING TRAFFIC SIGNAL EQUIPMENT	EACH	2
730-08.02	SIGNAL CABLE - 5 CONDUCTOR	L.F.	30
730-14.02	SAW SLOT	L.F.	2200
730-14.03	LOOP WIRE	L.F.	4800
740-10.03	GEOTEXTILE (TYPE III)(EROSION CONTROL)	S.Y.	180
803-01	SODDING (NEW SOD)	S.Y.	1300
801-03	WATER (SEEDING & SODDING)	M.G.	2

FOOTNOTES

- INCLUDES 180 TONS TO BE USED FOR TEMPORARY CONSTRUCTION EXITS.
- TO BE USED AS DIRECTED BY THE ENGINEER FOR TEMPORARY CONSTRUCTION EXITS.
- THE CONTRACTOR SHALL COMPLY WITH SECTION 712 OF THE STANDARD SPECIFICATIONS FOR ROAD AND BRIDGE CONSTRUCTION REGARDING TEMPORARY TRAFFIC CONTROL AND THE CURRENT EDITION OF THE MANUAL ON UNIFORM TRAFFIC CONTROL DEVICES.
- IN THE EVENT THAT A CONSTRUCTION AND/OR REGULATORY SIGN IS TEMPORAIRILY DESIGNATED NOT IN USE DURING THE CONSTRUCTION PHASE OF A PROJECT, THE CONTRACTOR SHALL CHOOSE A SIGN COVERING METHOD FROM A DESIGNATED LIST OF METHODS ACCEPTED BY THE DEPARTMENT. SAID SIGN COVERING METHOD SHALL BE SELECTED FROM QUALIFIED PRODUCTS LIST 10, SECTION D OR APPROVED BY THE DIVISION OF MATERIALS AND TEST AND SHALL BE USED TO COVER THESE SIGNS. NO OTHER METHOD FOR SIGN COVERING WILL BE ALLOWED. TEMPORARY SIGN COVERINGS SHALL NOT BE PAID FOR DIRECTLY BUT SHALL BE INCLUDED IN THE PRICE BID FOR ITEM NO. 712-06 SIGNS (CONSTRUCTION).
- THE CONTRACTOR MAY ELECT TO SUBSITUTE PREFORMED PLASTIC FOR THERMOPLASTIC. PREFORMED PLASTIC SHALL BE PAID FOR AT THE SAME UNIT PRICE AS BID FOR THERMOPLASTIC.
- FOR TEMPORARY PAVEMENT MARKING ON INTERMEDIATE LAYERS AND COLD PLANED SURFACE.
- QUANTITY IS FOR FINAL PAVEMENT MARKINGS.
- TO BE USED AS DIRECTED BY THE ENGINEER.
- QUANTITY INCLUDES 4 EACH OF STRAIGHT/LEFT TURN ARROWS.
- QUANTITY INCLUDES 10 EACH OF RIGHT TURN ARROWS AND 8 EACH OF LEFT TURN ARROWS.

CATCH BASINS AND MANHOLES							
SHEET NO.	LOCATION	STATION	OFFSET (FT.)	DRAINAGE CODE	GRATE/TOP ELEV.	DEPTH (FT.)	PAY ITEMS
							TYPE 42 611-42.02 4' - 8'
4A	MEDIAN	530+00.00	0	1	595.38	4.58	1
TOTALS							1

STORM DRAINAGE PIPES											
SHEET NO.	FROM		TO		% GRADE	REINFORCED CONC. PIPE - CLASS III SIZE & LENGTH (L.F.)					RIP-RAP 709-05.06 (TON)
	CODE	OUTLET ELEV.	CODE	INLET ELEV.		18"	24"	30"	36"	48"	
4A	1	590.80	CONN	589.69	0.64	173					
TOTALS						173	0	0	0	0	0

SIGNS (CONSTRUCTION) 712-06				
QUANTITY	M.U.T.C.D. NO.	DESCRIPTION	SIZE	712-06 S.F.
6	G20-2	END ROAD WORK	48 x 24	16
2	W20-1	ROAD WORK 1500'	48 x 48	32
2	W20-1	ROAD WORK 1000'	48 x 48	32
2	W20-1	ROAD WORK 500'	48 x 48	32
4	W20-1	ROAD WORK AHEAD	48 x 48	64
2	W20-4	ONE LANE ROAD 1000' - PORTABLE	36 x 36	18
2	W20-7a	FLAGGER SYMBOL - PORTABLE	36 x 36	18
2	W16-2	SUPPLEMENTAL PLATE	24 x 18	6
2	W21-2	FRESH OIL - PORTABLE	36 x 36	18
2	W21-5	SHOULDER WORK - PORTABLE	36 x 36	18
2	W8-9a	SHOULDER DROP-OFF - PORTABLE	36 x 36	18
6	W8-11	UNEVEN LANES - PORTABLE	36 x 36	54
TOTAL S.F.				326

OTHER SIGNS, AS DIRECTED BY THE ENGINEER MAY BE REQUIRED DURING VARIOUS PHASES OF CONSTRUCTION AND WILL BE MEASURED AND PAID FOR AT THE UNIT BID PRICE. SEE CURRENT M.U.T.C.D. FOR STANDARDS AND TYPICAL APPLICATIONS.

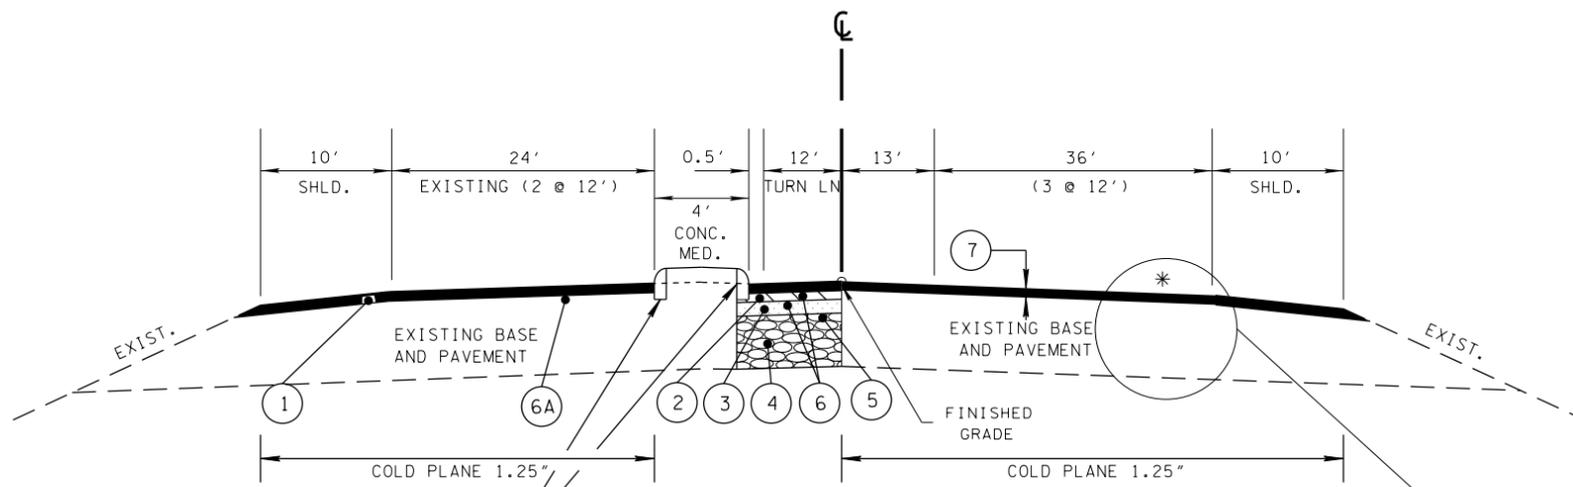
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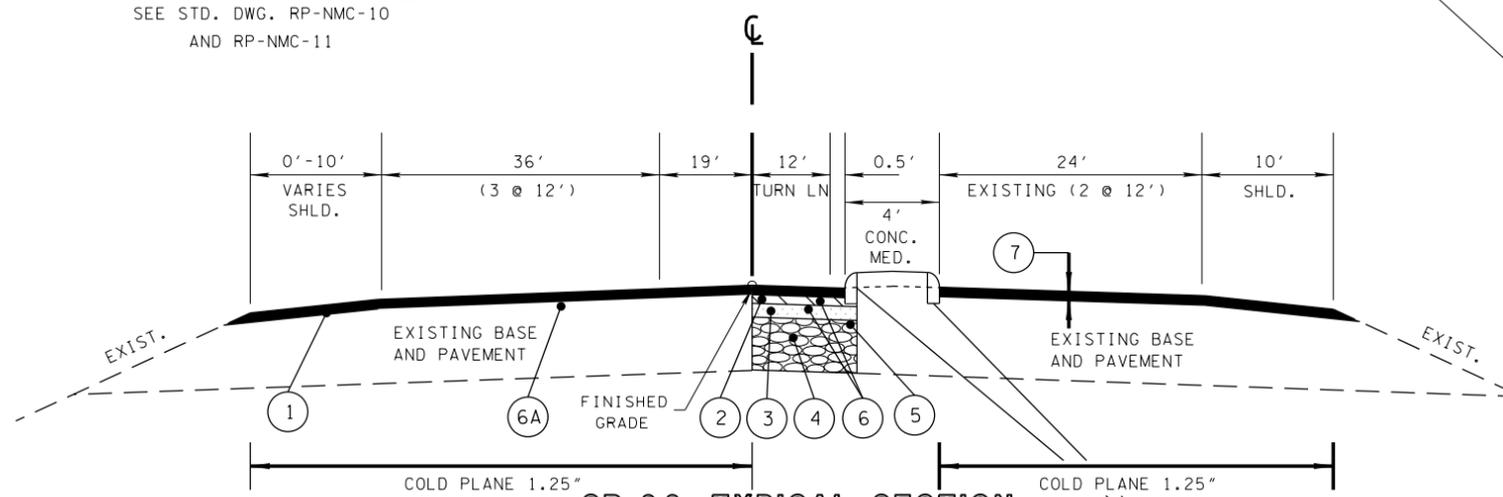
**ESTIMATED
ROADWAY
QUANTITIES
AND TABULATED
QUANTITIES**

TYPE	YEAR	PROJECT NO.	SHEET NO.
R.O.W.	2014	NH-SIP-96(36)	2
CONST.	2014	PHSIP/NH-SIP-96(36)	2A



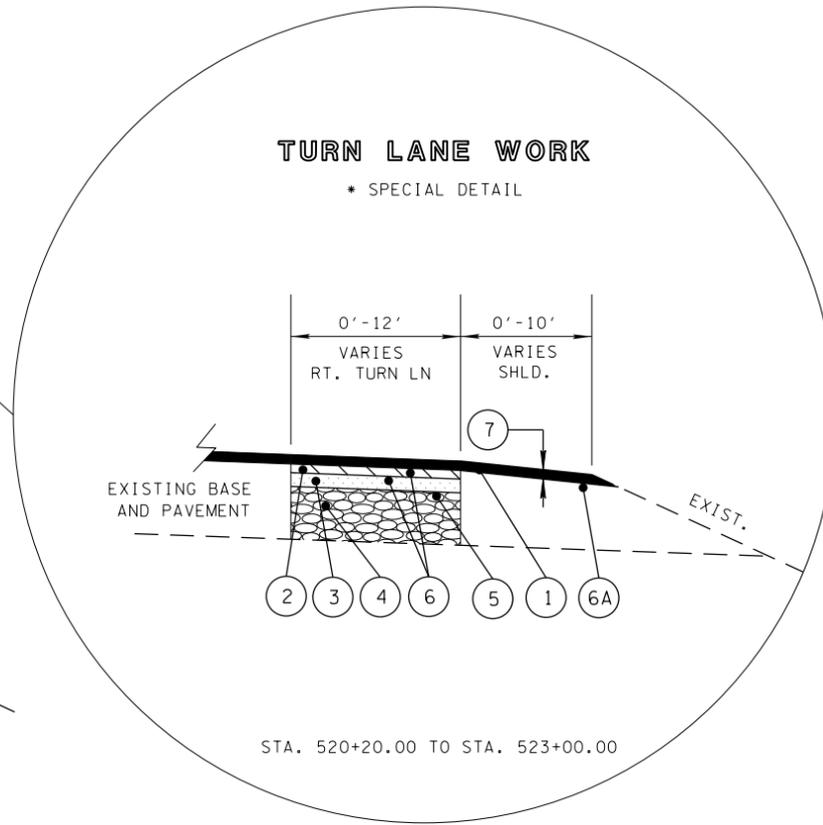
SR-96 TYPICAL SECTION
 BASED ON RD01-TS-3C
 STA. 520+00.00 TO STA. 524+50.00

TYPE A CONCRETE CURB
 SEE STD. DWG. RP-NMC-10
 AND RP-NMC-11



SR-96 TYPICAL SECTION
 BASED ON RD01-TS-3C
 STA. 525+90.36 TO STA. 531+50.00

TYPE A CONCRETE CURB
 SEE STD. DWG. RP-NMC-10
 AND RP-NMC-11



STA. 520+20.00 TO STA. 523+00.00

PROPOSED PAVEMENT SCHEDULE

① SURFACE @ 1.25" THICK (APPROX. 132.5 LBS/SY) 411-02.10 ACS MIX (PG70-22) GRADING D	⑤ PRIME COAT 402-01 BITUMINUS MATERIAL FOR PRIME COAT (PC) 402-02 AGGREGATE FOR COVER MATERIAL (PC)
② BINDER @ 2.00" THICK (APPROX. 226 LBS/SY) 307-02.08 ASPHALT CONCRETE MIX (PG70-22) (BPMB-HM) GRADING B-M2	⑥ TACT COAT @ 0.07 GAL/SY 403-01 BITUMINUS MATERIAL FOR TACT COAT (TC)
③ BLACK BASE @ 4.00" THICK (APPROX. 450 LBS/SY) 307-02.01 ASPHALT CONCRETE MIX (PG70-22) (BPMB-HM) GRADING A	⑥A TACT COAT @ 0.1 GAL/SY 403-01 BITUMINUS MATERIAL FOR TACT COAT (TC)
④ MINERAL AGGREGATE @ 10.00" THICK 303-01 MINERAL AGGREGATE, TYPE "A" BASE, GRADING D	⑦ COLD PLANING @ 1.25" THICK 415-01.01 COLD PLANING BITUMINOUS PAVEMENT

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**TYPICAL
 SECTIONS
 AND
 PAVEMENT
 SCHEDULE**

TYPE	YEAR	PROJECT NO.	SHEET NO.
CONST.	2014	PHSIP/NH-SIP-96(36)	2B

GENERAL NOTES

GRADING

- (1) ANY AREA THAT IS DISTURBED OUTSIDE LIMITS OF CONSTRUCTION DURING THE LIFE OF THIS PROJECT SHALL BE REPAIRED BY THE CONTRACTOR AT HIS EXPENSE.
- (2) THE CONTRACTOR SHALL NOT DISPOSE OF ANY MATERIAL EITHER ON OR OFF STATE-OWNED R.O.W. IN A REGULATORY FLOOD WAY AS DEFINED BY THE FEDERAL EMERGENCY MANAGEMENT AGENCY WITHOUT APPROVAL BY SAME. ALL MATERIAL SHALL BE DISPOSED OF IN UPLAND (NON-WETLAND) AREAS AND ABOVE ORDINARY HIGH WATER OF ANY ADJACENT WATERCOURSE. THIS DOES NOT ELIMINATE THE NEED TO OBTAIN ANY OTHER LICENSES OR PERMITS THAT MAY BE REQUIRED BY ANY OTHER FEDERAL, STATE OR LOCAL AGENCY.

DRAINAGE

- (3) EXCAVATION FOR STORM SEWERS WILL NOT BE MEASURED AND PAID FOR DIRECTLY, BUT WILL BE INCLUDED IN THE PRICE BID PER LINEAR FOOT OF PIPE (PIPE CULVERTS, STORM SEWERS, CONDUITS, ALL OTHER CULVERTS AND MINOR STRUCTURES).
- (4) DURING CONSTRUCTION OF DRAINAGE STRUCTURES ALL COST ASSOCIATED WITH MAINTAINING THE FLOW OF WATER AND TRAFFIC, AT THESE STRUCTURES, DURING THE PHASED CONSTRUCTION OF THIS PROJECT ARE TO BE INCLUDED IN THE UNIT PRICE OF THE DRAINAGE STRUCTURES AND TRAFFIC CONTROL ITEMS.

MISCELLANEOUS

- (5) THE CONTRACTOR SHALL BE REQUIRED TO REMOVE AND RESET MAILBOXES WHERE AND AS DIRECTED BY THE ENGINEER.
- (6) NOTHING IN THE GENERAL NOTES OR SPECIAL PROVISIONS SHALL RELIEVE THE CONTRACTOR FROM HIS RESPONSIBILITIES TOWARD THE SAFETY AND CONVENIENCE OF THE GENERAL PUBLIC AND THE RESIDENTS ALONG THE PROPOSED CONSTRUCTION AREA

PAVEMENT MARKINGS

TEMPORARY PAVEMENT MARKING ON INTERMEDIATE LAYERS

- (7) TEMPORARY PAVEMENT LINE MARKINGS ON INTERMEDIATE LAYERS OF PAVEMENT SHALL BE REFLECTIVE TAPE OR REFLECTORIZED PAINT INSTALLED TO PERMANENT STANDARDS AT THE END OF EACH DAY'S WORK. SHORT, UNMARKED SECTIONS SHALL NOT BE ALLOWED. THESE MARKINGS WILL BE MEASURED AND PAID FOR UNDER ITEM NO. 716-05.01, PAINTED PAVEMENT MARKING (4" LINE), L.M.

FINAL PAVEMENT MARKING IF 6" ENHANCED FLATLINE THERMOPLASTIC IS USED

- (8) PERMANENT PAVEMENT LINE MARKINGS SHALL BE 6" ENHANCED FLATLINE THERMOPLASTIC INSTALLED TO PERMANENT STANDARDS AT THE END OF EACH DAY'S WORK. SHORT UNMARKED SECTIONS SHALL NOT BE ALLOWED. PAVEMENT MARKINGS WILL BE MEASURED AND PAID FOR UNDER ITEM NO. 716-12.02, ENHANCED FLATLINE THERMO PVMT MRKNG (6IN LINE), L.M. THE CONTRACTOR SHALL HAVE THE OPTION OF USING REFLECTORIZED PAINT INSTALLED TO PERMANENT STANDARDS AT THE END OF EACH DAY'S WORK AND THEN INSTALLING THE PERMANENT MARKINGS AFTER THE PAVING OPERATION IS COMPLETED. THE TEMPORARY MARKINGS FOR THE FINAL SURFACE WILL NOT BE MEASURED AND PAID FOR DIRECTLY, BUT THE COSTS ARE TO BE INCLUDED IN THE PRICE BID FOR THE PERMANENT MARKINGS.

PAVEMENT

PAVING

- (9) THE CONTRACTOR SHALL BE REQUIRED TO COLD PLANE AND PAVE IN THE DIRECTION OF TRAFFIC.
- (10) THE CONTRACTOR SHALL ATTACH A DEVICE TO THE SCREED OF THE PAVER SUCH THAT MATERIAL IS CONFINED AT THE END GATE AND EXTRUDES THE ASPHALT MATERIAL IN SUCH A WAY THAT RESULTS IN A CONSOLIDATED WEDGE-SHAPE PAVEMENT EDGE OF APPROXIMATELY 25 TO 30 DEGREES AS IT LEAVES THE PAVER (MEASURED FROM A LINE PARALLEL TO THE PAVEMENT SURFACE.) THE DEVICE SHALL MEET THE REQUIREMENTS THAT ARE CURRENTLY SET FORTH IN SPECIAL PROVISION 407SE.

RESURFACING

- (11) WHERE DIRECTED BY THE TDOT ENGINEER, THE CONTRACTOR SHALL BE REQUIRED TO SHAPE PUBLIC SIDE ROADS, BUSINESS ENTRANCES, AND

PRIVATE DRIVES, AS WELL AS CLEANING OF EXISTING DRAINS BEFORE PLACING MATERIALS. ALL COSTS ARE TO BE INCLUDED IN THE PRICE BID FOR OTHER ITEMS OF CONSTRUCTION.

- (12) ALL PUBLIC SIDE ROADS SHALL BE PAVED ONE PAVER WIDTH THROUGH THE INTERSECTION AS A MINIMUM. A SATISFACTORY TRANSITION FROM THE NEW PAVEMENT TO THE EXISTING GRADE OF THE INTERSECTING PUBLIC ROAD OR BUSINESS ENTRANCE SHALL BE PROVIDED. SHOULD THE PAVEMENT OF THE INTERSECTING PUBLIC ROAD BE DISTRESSED, THE RESURFACING WIDTH MAY BE INCREASED TO THE NORMAL RIGHT OF WAY LINE.
- (13) PRIVATE DRIVEWAYS, FIELD ENTRANCES, AND BUSINESS ENTRANCES WILL BE RESURFACED A PAVER WIDTH (LANE WIDTH) AS A MINIMUM. A PAVEMENT TAPER TO TRANSITION THE NEW PAVEMENT SHALL BE REQUIRED, IT SHALL BE BASED ON AN ADDITIONAL ONE FOOT OF WIDTH PER ONE INCH DEPTH OF PAVEMENT. IF THE SHOULDER IS NARROW ENOUGH THAT THE SUM OF THE SHOULDER AND THE TRANSITION ARE LESS THAN A PAVER WIDTH, THE TRANSITION SHALL OCCUR WITHIN THE PAVER WIDTH. IF THE SUM OF THE SHOULDER AND THE TRANSITION IS GREATER THAN A PAVER WIDTH (LANE WIDTH), THE TRANSITION SHALL OCCUR OUTSIDE OF THE PAVER WIDTH.
- (14) ON CURB AND GUTTER SECTIONS, PUBLIC ROAD INTERSECTIONS SHALL BE RESURFACED TO THE END OF RADIUS. A SATISFACTORY TRANSITION FROM THE NEW PAVEMENT TO THE EXISTING GRADE OF THE INTERSECTING PUBLIC ROAD SHALL BE PROVIDED.
- (15) ON URBAN TYPICAL SECTIONS, (CURB AND GUTTER), RESIDENTIAL DRIVEWAYS AND BUSINESS ENTRANCES SHALL HAVE A MINIMUM WIDTH OF MATERIAL NOT LESS THAN ONE FOOT USED IN THE TRANSITION TO FEATHER THE PAVEMENT EDGE.
- (16) IN ALL CASES, THE LENGTH OF THE PAVEMENT TRANSITION, THE THICKNESS AND WIDTH OF THE RESURFACING AND ANY ADDITIONAL PAVEMENT MATERIALS SHALL BE AS DIRECTED BY THE TDOT ENGINEER.

SIGNALIZATION

- (17) EQUIPMENT AND INSTALLATION OF TRAFFIC SIGNALS SHALL COMPLY WITH TDOT STANDARD SPECIFICATIONS, SECTION 730.
- (18) IF RESURFACING IS INCLUDED IN THE PROJECT, SIGNAL DETECTION LOOPS SHALL BE INSTALLED BEFORE THE FINAL SURFACE IS APPLIED.
- (19) ANY SIGNAL HEADS, WHEN VISIBLE TO DRIVERS BUT NOT OPERATIONAL, SHALL BE COMPLETELY COVERED.
- (20) LOOPS SHALL BE INSTALLED IN THE LEVELING COURSE IF A LEVELING COURSE IS PROVIDED.
- (21) LOOP REPLACEMENT SHALL BE IN ACCORDANCE WITH SECTION 730 OF THE STANDARD SPECIFICATIONS.

CONSTRUCTION WORK ZONE & TRAFFIC CONTROL

- (22) ADVANCED WARNING SIGNS SHALL NOT BE DISPLAYED MORE THAN FORTY-EIGHT (48) HOURS BEFORE PHYSICAL CONSTRUCTION BEGINS. SIGNS MAY BE ERECTED UP TO ONE WEEK BEFORE NEEDED, IF THE SIGN FACE IS FULLY COVERED.
- (23) IF THE CONTRACTOR MOVES OFF THE PROJECT, HE SHALL COVER OR REMOVE ALL UNNEEDED SIGNS AS DIRECTED BY THE ENGINEER. COSTS OF REMOVAL, COVERING, AND REINSTALLING SIGNS SHALL NOT BE MEASURED AND PAID FOR SEPARATELY, BUT ALL COSTS SHALL BE INCLUDED IN THE ORIGINAL UNIT PRICE BID FOR ITEM NO 712-06, SIGNS (CONSTRUCTION) PER SQUARE FOOT.
- (24) A LONG TERM BUT SPORADIC USE WARNING SIGN, SUCH AS A FLAGGER SIGN, MAY REMAIN IN PLACE WHEN NOT REQUIRED PROVIDED THE SIGN FACE IS FULLY COVERED.
- (25) TRAFFIC CONTROL DEVICES SHALL NOT BE DISPLAYED OR ERECTED UNLESS RELATED CONDITIONS ARE PRESENT NECESSITATING WARNING.
- (26) USE OF BARRICADES, PORTABLE BARRIER RAILS, VERTICAL PANELS, AND DRUMS SHALL BE LIMITED TO THE IMMEDIATE AREAS OF CONSTRUCTION WHERE A HAZARD IS PRESENT. THESE DEVICES SHALL NOT BE STORED ALONG THE ROADWAY WITHIN THIRTY (30) FEET OF THE EDGE OF THE TRAVELED WAY BEFORE OR AFTER USE UNLESS PROTECTED BY GUARDRAIL, BRIDGE RAIL, AND/OR BARRIERS INSTALLED FOR OTHER PURPOSES FOR ROADWAYS WITH CURRENT ADT'S LESS THAN 1500 AND DESIGN SPEED OF LESS THAN 60 MPH. THIS DISTANCE SHALL INCREASE TO FORTY-FIVE (45) FEET FOR ROADWAYS WITH CURRENT ADT'S OF 1500 OR GREATER AND DESIGN SPEED OF 60 MPH OR GREATER OR ON THE

OUTSIDE OF A HORIZONTAL CURVE. THESE DEVICES SHALL BE REMOVED FROM THE CONSTRUCTION WORK ZONE WHEN THE ENGINEER DETERMINES THEY ARE NO LONGER NEEDED. WHERE THERE IS INSUFFICIENT RIGHT-OF-WAY TO PROVIDE FOR THIS REQUIRED SETBACK, THE CONTRACTOR SHALL DETERMINE THE ALTERNATE LOCATIONS AND REQUEST THE ENGINEER'S APPROVAL TO USE THEM.

- (27) THE CONTRACTOR SHALL NOT BE PERMITTED TO PARK ANY VEHICLES OR CONSTRUCTION EQUIPMENT DURING PERIODS OF INACTIVITY, WITHIN THIRTY (30) FEET OF THE EDGE OF PAVEMENT WHEN THE LANE IS OPEN TO TRAFFIC UNLESS PROTECTED BY GUARDRAIL, BRIDGE RAIL, AND/OR BARRIERS INSTALLED FOR OTHER PURPOSES FOR ROADWAYS WITH CURRENT ADT'S LESS THAN 1500 AND DESIGN SPEED OF LESS THAN 60 MPH. THIS DISTANCE SHALL BE INCREASED TO FORTY-FIVE (45) FEET FOR ROADWAYS WITH CURRENT ADT'S OF 1500 OR GREATER AND DESIGN SPEED OF 60 MPH OR GREATER OR ON THE OUTSIDE OF A HORIZONTAL CURVE. PRIVATELY OWNED VEHICLES SHALL NOT BE ALLOWED TO PARK WITHIN THIRTY (30) FEET OF A OPEN TRAFFIC LANE AT ANY TIME UNLESS PROTECTED AS DESCRIBED ABOVE FOR ROADWAYS WITH CURRENT ADT'S LESS THAN 1500 AND DESIGN SPEED OF LESS THAN 60 MPH. THIS DISTANCE SHALL BE INCREASED TO FORTY-FIVE (45) FEET FOR ROADWAYS WITH CURRENT ADT'S OF 1500 OR GREATER AND DESIGN SPEED OF 60 MPH OR GREATER OR ON THE OUTSIDE OF A HORIZONTAL CURVE.. WHERE THERE IS INSUFFICIENT RIGHT-OF-WAY TO PROVIDE FOR THIS REQUIRED SETBACK, THE CONTRACTOR SHALL DETERMINE THE ALTERNATE LOCATIONS AND REQUEST THE ENGINEER'S APPROVAL TO USE THEM.
- (28) ALL DETOUR AND CONSTRUCTION SIGNING SHALL BE IN STRICT ACCORDANCE WITH THE MANUAL ON UNIFORM TRAFFIC CONTROL DEVICES.
- (29) ALL DETOURS SHALL BE PAVED, STRIPED, SIGNED AND THE VERTICAL PANELS ARE TO BE IN PLACE BEFORE IT IS OPENED TO TRAFFIC.

EROSION PREVENTION AND SEDIMENT CONTROL

LITTER, DEBRIS, WASTE, PETROLEUM

- (30) THE CONTRACTOR SHALL ESTABLISH AND MAINTAIN A PROACTIVE METHOD TO PREVENT LITTER, CONSTRUCTION DEBRIS, AND CONSTRUCTION WASTES FROM ENTERING WATERS OF THE STATE/U.S. THESE MATERIALS WILL BE PICKED UP AND REMOVED FROM STORMWATER EXPOSURE PRIOR TO ANTICIPATED STORM EVENTS. AFTER USE, MATERIALS USED FOR EPSC WILL BE REMOVED FROM THE SITE.
- (31) THE CONTRACTOR SHALL TAKE APPROPRIATE STEPS TO ENSURE THAT PETROLEUM PRODUCTS OR OTHER CHEMICAL POLLUTANTS ARE PREVENTED FROM ENTERING WATERS OF THE STATE/U.S. ALL EQUIPMENT REFUELING, SERVICING, AND STAGING AREAS SHALL COMPLY WITH ALL LOCAL, STATE, AND FEDERAL LAWS, RULES, REGULATIONS, AND ORDINANCES, INCLUDING THOSE OF THE NATIONAL FIRE PROTECTION ASSOCIATION (NFPA). APPROPRIATE CONTAINMENT MEASURES FOR THESE AREAS SHALL BE USED. ALL SPILLS MUST BE REPORTED TO THE APPROPRIATE AGENCY, AND MEASURES SHALL BE TAKEN IMMEDIATELY TO PREVENT THE POLLUTION OF WATERS OF THE STATE/U.S., INCLUDING GROUNDWATER, SHOULD A SPILL OCCUR.

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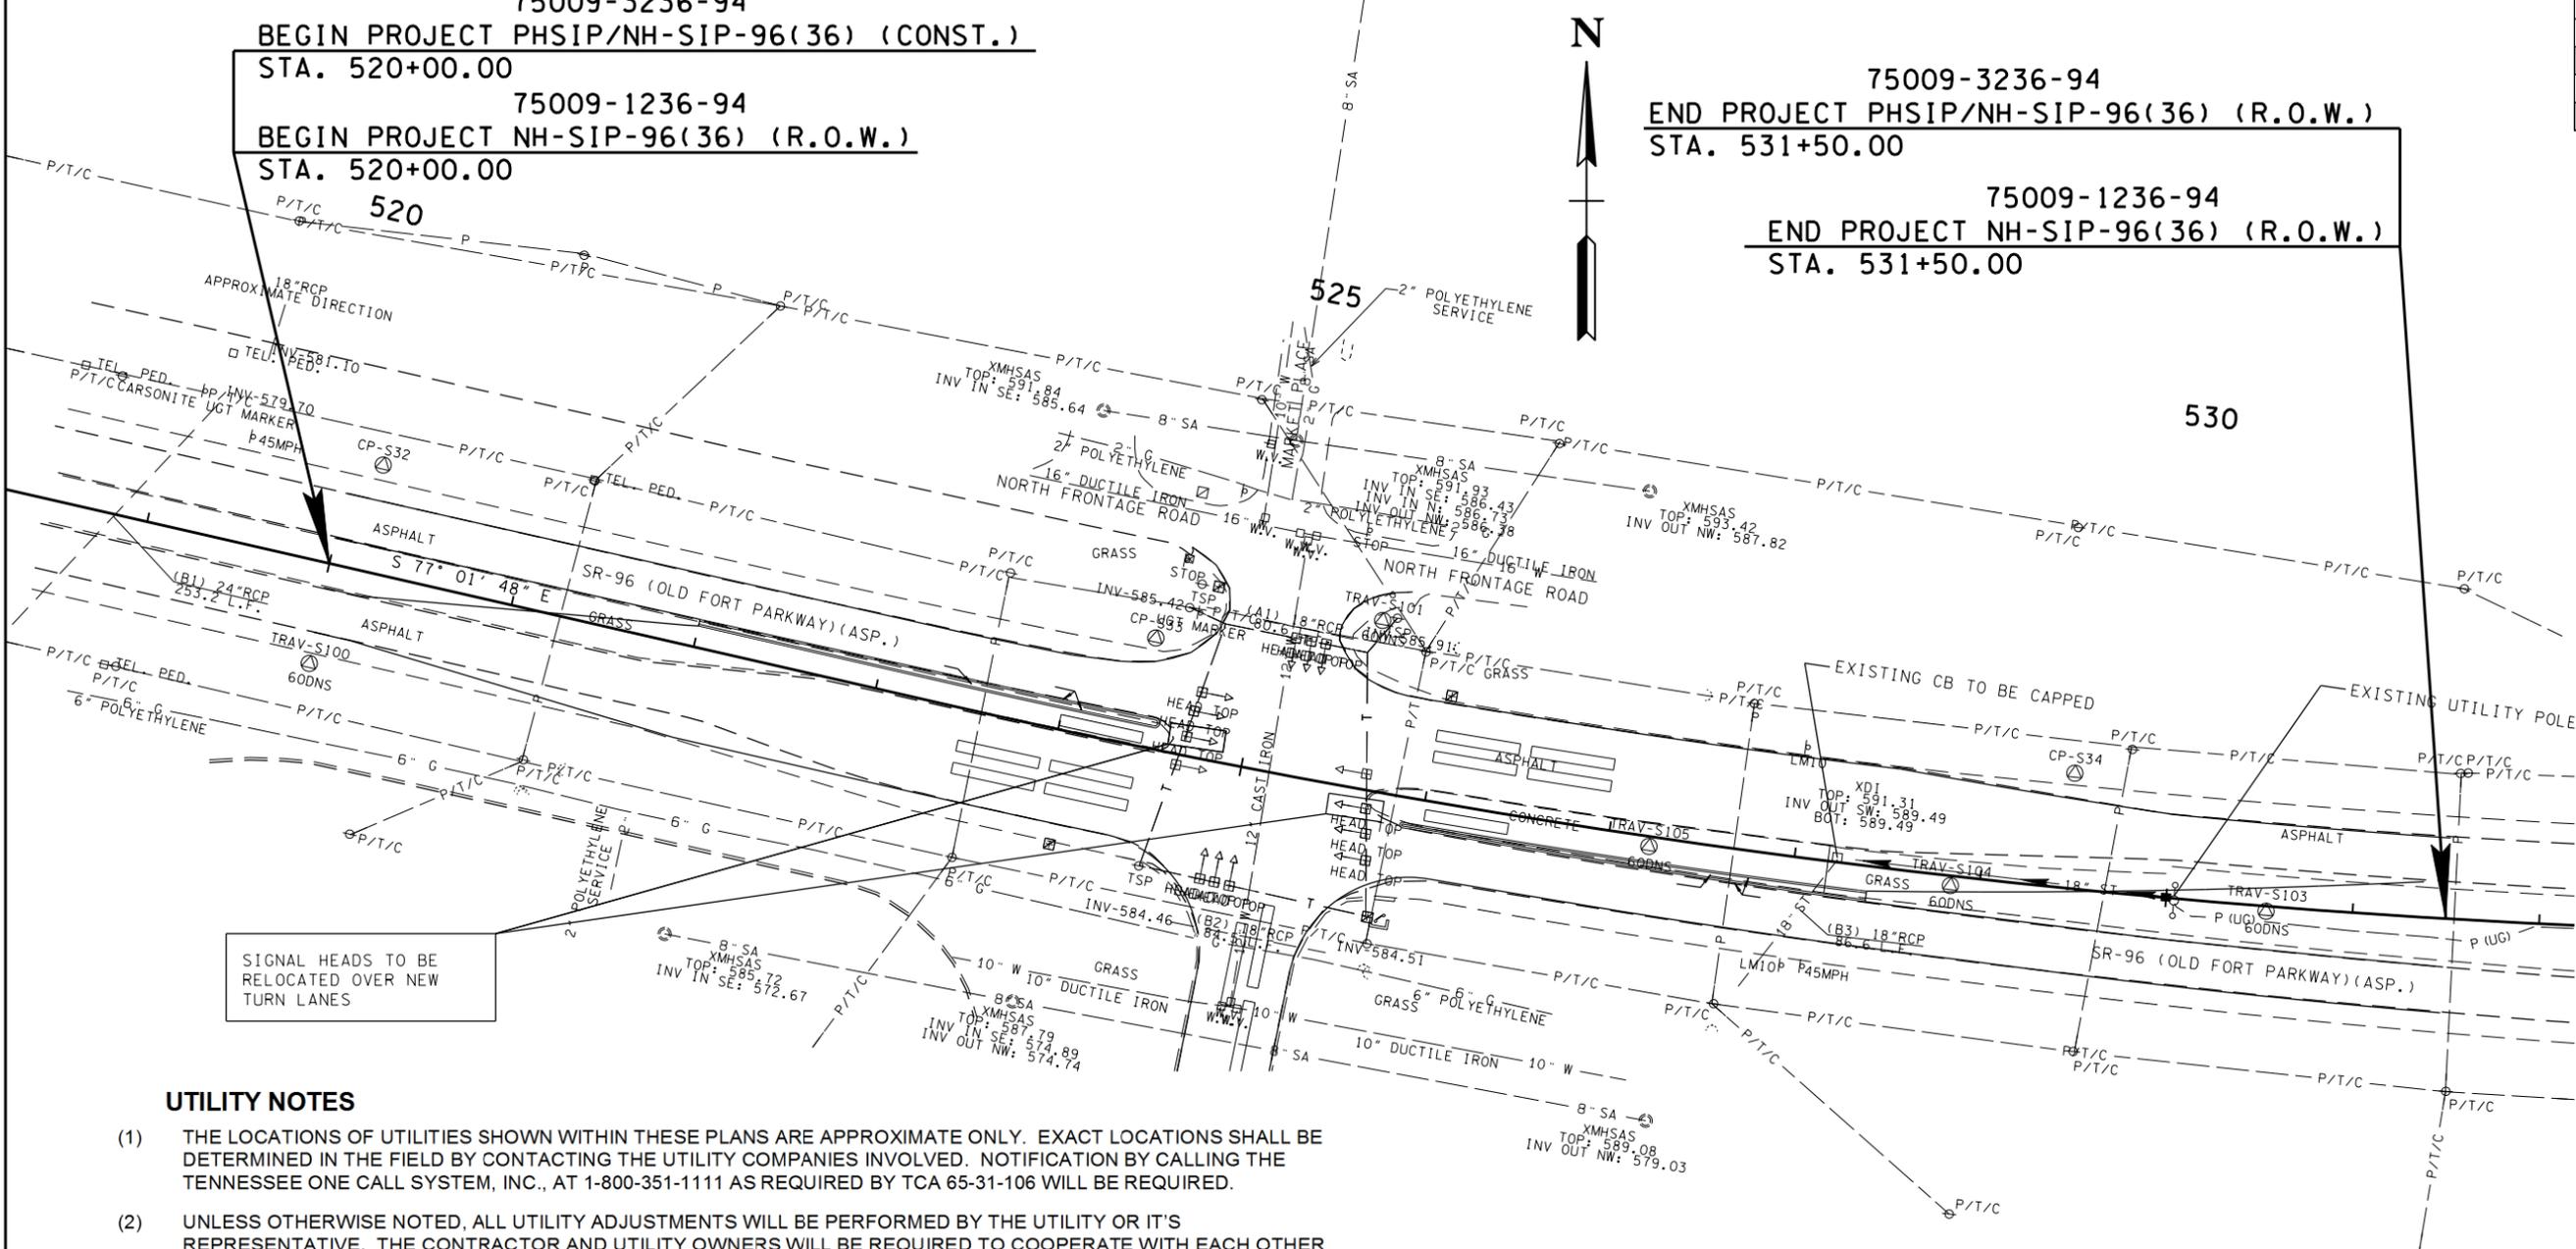
STATE OF TENNESSEE
DEPARTMENT OF TRANSPORTATION

**GENERAL
NOTES**

TYPE	YEAR	PROJECT NO.	SHEET NO.
R.O.W.	2014	52946-0411-04	3
CONST.	2014	PHSIP/NH-SIP-96(36)	3

75009-3236-94
 BEGIN PROJECT PHSIP/NH-SIP-96(36) (CONST.)
 STA. 520+00.00
 75009-1236-94
 BEGIN PROJECT NH-SIP-96(36) (R.O.W.)
 STA. 520+00.00

75009-3236-94
 END PROJECT PHSIP/NH-SIP-96(36) (R.O.W.)
 STA. 531+50.00
 75009-1236-94
 END PROJECT NH-SIP-96(36) (R.O.W.)
 STA. 531+50.00



SIGNAL HEADS TO BE RELOCATED OVER NEW TURN LANES

UTILITY NOTES

- (1) THE LOCATIONS OF UTILITIES SHOWN WITHIN THESE PLANS ARE APPROXIMATE ONLY. EXACT LOCATIONS SHALL BE DETERMINED IN THE FIELD BY CONTACTING THE UTILITY COMPANIES INVOLVED. NOTIFICATION BY CALLING THE TENNESSEE ONE CALL SYSTEM, INC., AT 1-800-351-1111 AS REQUIRED BY TCA 65-31-106 WILL BE REQUIRED.
- (2) UNLESS OTHERWISE NOTED, ALL UTILITY ADJUSTMENTS WILL BE PERFORMED BY THE UTILITY OR IT'S REPRESENTATIVE. THE CONTRACTOR AND UTILITY OWNERS WILL BE REQUIRED TO COOPERATE WITH EACH OTHER IN ORDER TO EXPEDITE THE WORK REQUIRED BY THIS CONTRACT. ON CONTRACTS WHERE CONSTRUCTION STAKES, LINES, AND GRADES ARE CONTRACT ITEMS, THE CONTRACTOR WILL BE REQUIRED TO PROVIDE RIGHT-OF-WAY OR SLOPE STAKES, DITCH OR STREAM BED GRADES, OR OTHER ESSENTIAL SURVEY STAKING TO PREVENT CONFLICTS WITH THE HIGHWAY CONSTRUCTION. FREQUENTLY, THIS WILL BE REQUIRED AS THE FIRST ITEM OF WORK AND AT ANY LOCATION ON THE PROJECT DIRECTED BY THE ENGINEER.
- (3) THE CONTRACTOR WILL PROVIDE ALL NECESSARY PROTECTIVE MEASURES TO SAFEGUARD EXISTING UTILITIES FROM DAMAGE DURING CONSTRUCTION OF THIS PROJECT. IN THE EVENT THAT SPECIAL EQUIPMENT IS REQUIRED TO WORK OVER AND AROUND THE UTILITIES, THE CONTRACTOR WILL BE REQUIRED TO FURNISH SUCH EQUIPMENT. THE COST OF PROTECTING UTILITIES FROM DAMAGE AND FURNISHING SPECIAL EQUIPMENT WILL BE INCLUDED IN THE PRICE BID FOR OTHER ITEMS OF CONSTRUCTION.
- (4) PRIOR TO SUBMITTING HIS BID, THE CONTRACTOR WILL BE SOLELY RESPONSIBLE FOR CONTACTING OWNERS OF ALL AFFECTED UTILITIES IN ORDER TO DETERMINE THE EXTENT TO WHICH UTILITY RELOCATIONS AND/OR ADJUSTMENTS WILL HAVE UPON THE SCHEDULE OF WORK FOR THE PROJECT. WHILE SOME WORK MAY BE REQUIRED 'AROUND' UTILITY FACILITIES THAT WILL REMAIN IN PLACE, OTHER UTILITY FACILITIES MAY NEED TO BE ADJUSTED CONCURRENTLY WITH THE CONTRACTOR'S OPERATIONS. ADVANCE CLEAR CUTTING MAY BE REQUIRED BY THE ENGINEER AT ANY LOCATION WHERE CLEARING IS CALLED FOR IN THE SPECIFICATIONS AND CLEAR CUTTING IS NECESSARY FOR A UTILITY RELOCATION. ANY ADDITIONAL COST WILL BE INCLUDED IN THE UNIT PRICE BID FOR THE CLEARING ITEM SPECIFIED IN THE PLANS.
- (5) THE CONTRACTOR SHALL NOTIFY EACH INDIVIDUAL UTILITY OWNER OF HIS PLAN OF OPERATION IN THE AREA OF THE UTILITIES. PRIOR TO COMMENCING WORK, THE CONTRACTOR SHALL CONTACT THE UTILITY OWNERS AND REQUEST THEM TO PROPERLY LOCATE THEIR RESPECTIVE UTILITY ON THE GROUND. THIS NOTIFICATION SHALL BE GIVEN AT LEAST THREE (3) BUSINESS DAYS PRIOR TO COMMENCEMENT OF OPERATIONS AROUND THE UTILITY IN ACCORDANCE WITH TCA 65-31-106.

RUTHERFORD COUNTY UTILITIES

ELECTRIC MURFREESBORO ELECTRIC DEPARTMENT 205 N WALNUT ST MURFREESBORO, TN 37129 BRANDON HORNE bhorne@medtn.com OFFICE PHONE (615) 494-0424	NATURAL GAS ATMOS ENERGY 810 CRESENT CENTRE DR. SUITE 600 FRANKLIN, TN. 37067 ROBERT ARNOLD Robert.arnold@atmosenergy.com OFFICE PHONE (615) 771-8311 CELL PHONE (615) 310-3020	TELEPHONE AT&T 116 SOUTH CANON AVE. MURFREESBORO, TN. 37129 KENNETH KORNEGAY Kk4096@att.com OFFICE PHONE (615) 848-2082
CABLE COMCAST/XFINITY 660 MAINSTREAM DRIVE NASHVILLE, TN. 37228 LARRY K. WINBURN larry_winburn@cable.comcast.com OFFICE PHONE (615) 244-7462 ext. 1115251 CELL PHONE (615) 290-2372	WATER & SANITARY SEWER CITY OF MURFREESBORO 220 N.W. BROAD ST. MURFREESBORO, TN 37130 DARREN GORE dgore@murfreesborotn.gov OFFICE PHONE (615) 848-3209	

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UTILITIES

STA. 520+00 TO STA. 531+50

SCALE: 1" = 50'

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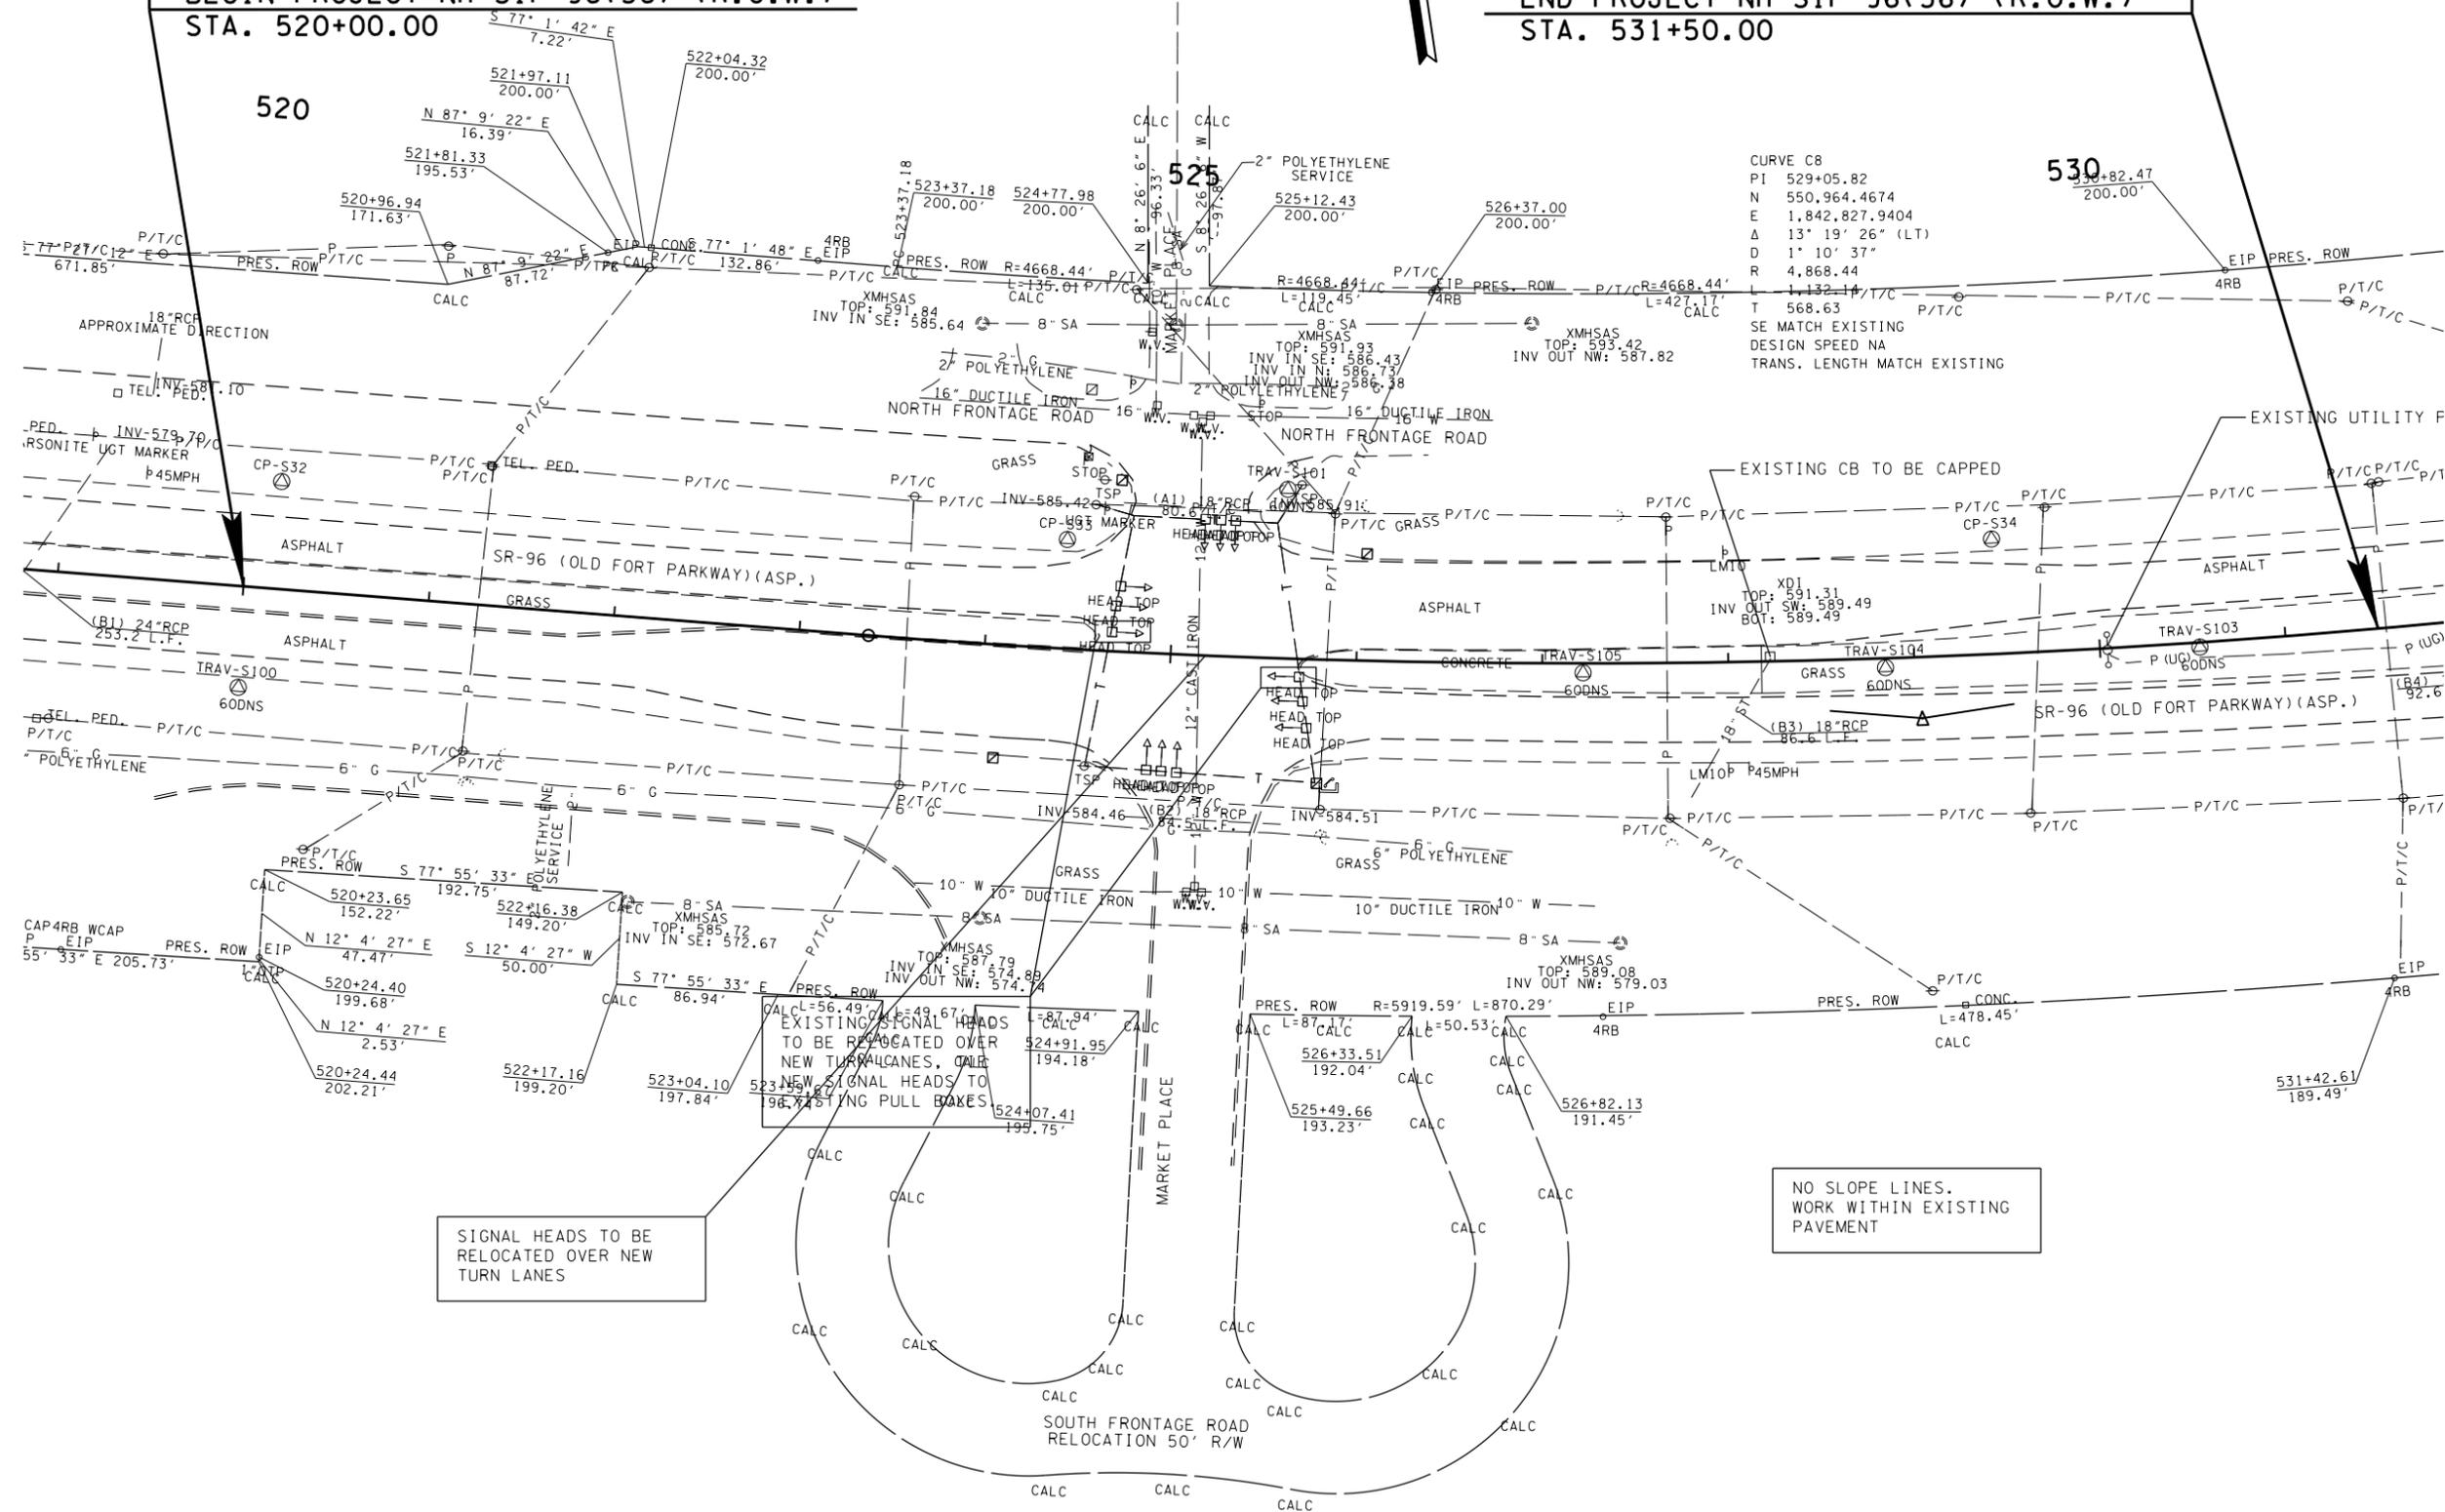
TYPE	YEAR	PROJECT NO.	SHEET NO.
R.O.W.	2014	NH-SIP-96(36)	4
CONST.	2014	PHSIP/NH-SIP-96(36)	4

75009-3236-94
 BEGIN PROJECT PHSIP/NH-SIP-96(36) (CONST.)
 STA. 520+00.00

75009-3236-94
 END PROJECT PHSIP/NH-SIP-96(36) (CONST.)
 STA. 531+50.00

75009-1236-94
 BEGIN PROJECT NH-SIP-96(36) (R.O.W.)
 STA. 520+00.00

75009-1236-94
 END PROJECT NH-SIP-96(36) (R.O.W.)
 STA. 531+50.00



CURVE C8
 PI 529+05.82
 N 550,964.4674
 E 1,842,827.9404
 Δ 13° 19' 26" (LT)
 D 1' 10' 37"
 R 4,868.44
 L 1,132.17
 T 568.63
 SE MATCH EXISTING
 DESIGN SPEED NA
 TRANS. LENGTH MATCH EXISTING

SIGNAL HEADS TO BE RELOCATED OVER NEW TURN LANES, OVER NEW TURN LANES, OVER EXISTING PULL BOXES

NO SLOPE LINES.
 WORK WITHIN EXISTING PAVEMENT

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 COORDINATES ARE NAD/83(1995),
 ARE DATUM ADJUSTED BY THE
 FACTOR OF 1.00008 AND TIED TO
 THE TGRN. ALL ELEVATIONS ARE
 REFERENCED TO THE NAVD 1988.

STATE OF TENNESSEE
 DEPARTMENT OF TRANSPORTATION

**PRESENT
 LAYOUT**

STA. 520+00 TO STA. 531+50

SCALE: 1" = 50'

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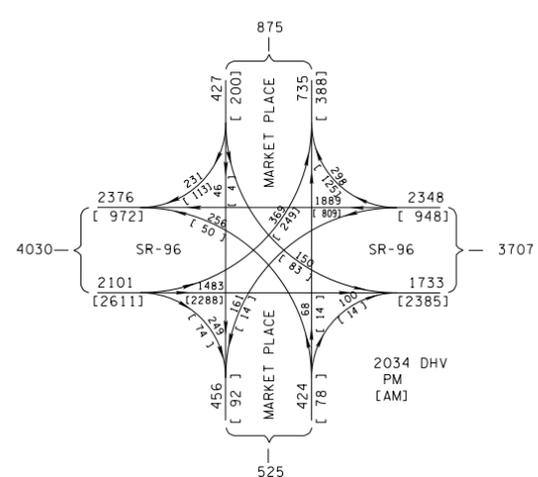
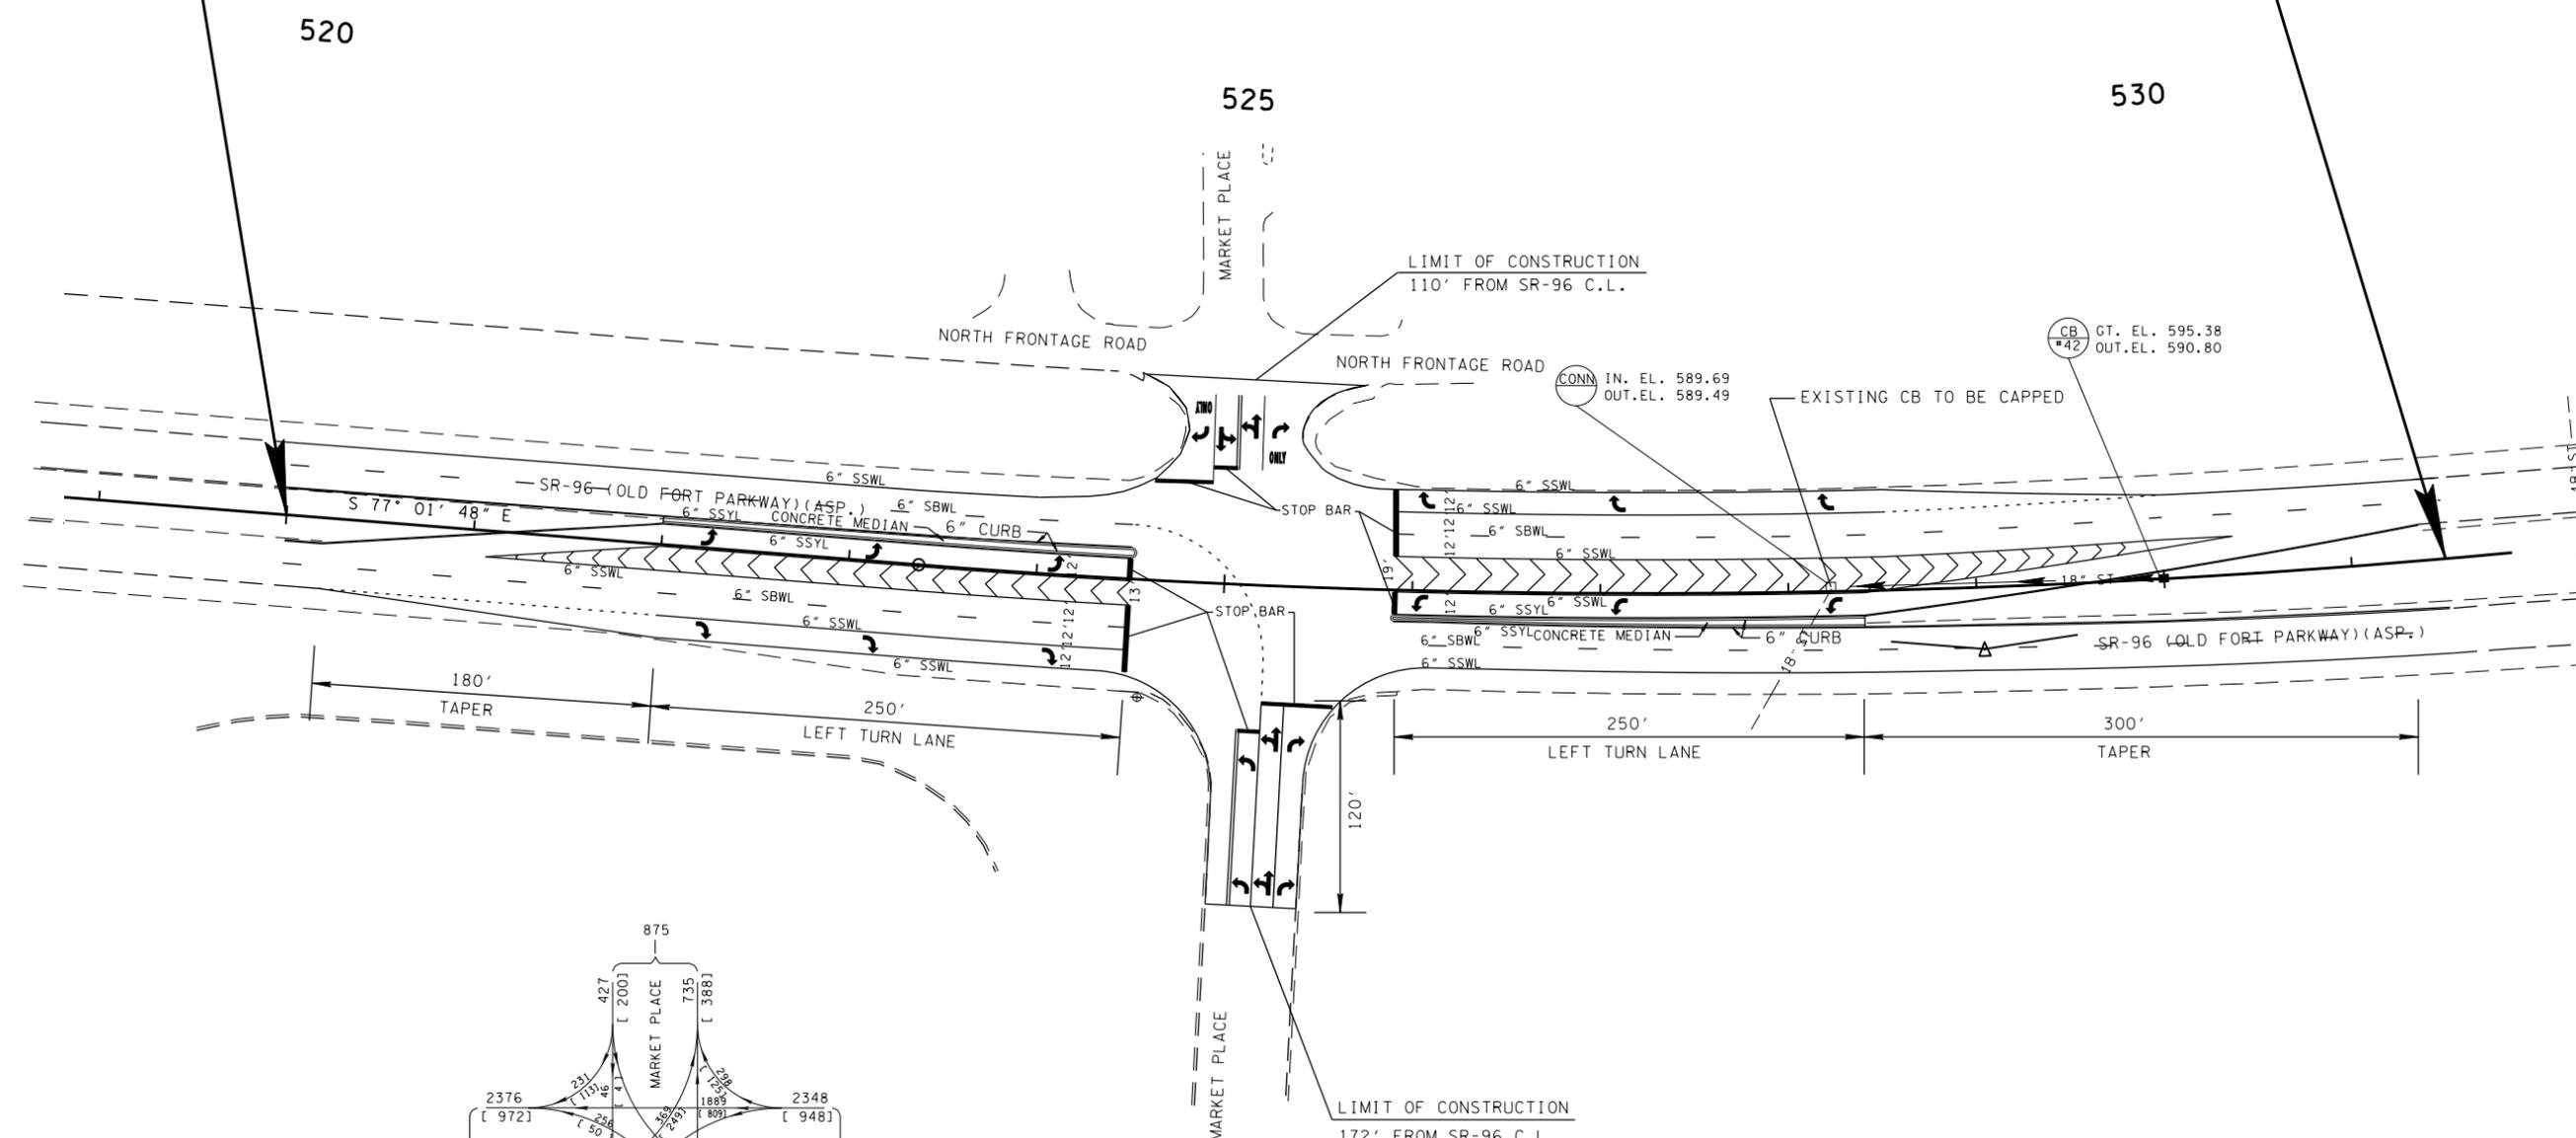
TYPE	YEAR	PROJECT NO.	SHEET NO.
R.O.W.	2014	NH-SIP-96(36)	4A
CONST.	2014	PHSIP/NH-SIP-96(36)	4A

75009-3236-94
 BEGIN PROJECT PHSIP/NH-SIP-96(36) (CONST.)
 STA. 520+00.00

75009-1236-94
 BEGIN PROJECT NH-SIP-96(36) (R.O.W.)
 STA. 520+00.00

75009-3236-94
 END PROJECT PHSIP/NH-SIP-96(36) (CONST.)
 STA. 531+50.00

75009-1236-94
 END PROJECT NH-SIP-96(36) (R.O.W.)
 STA. 531+50.00



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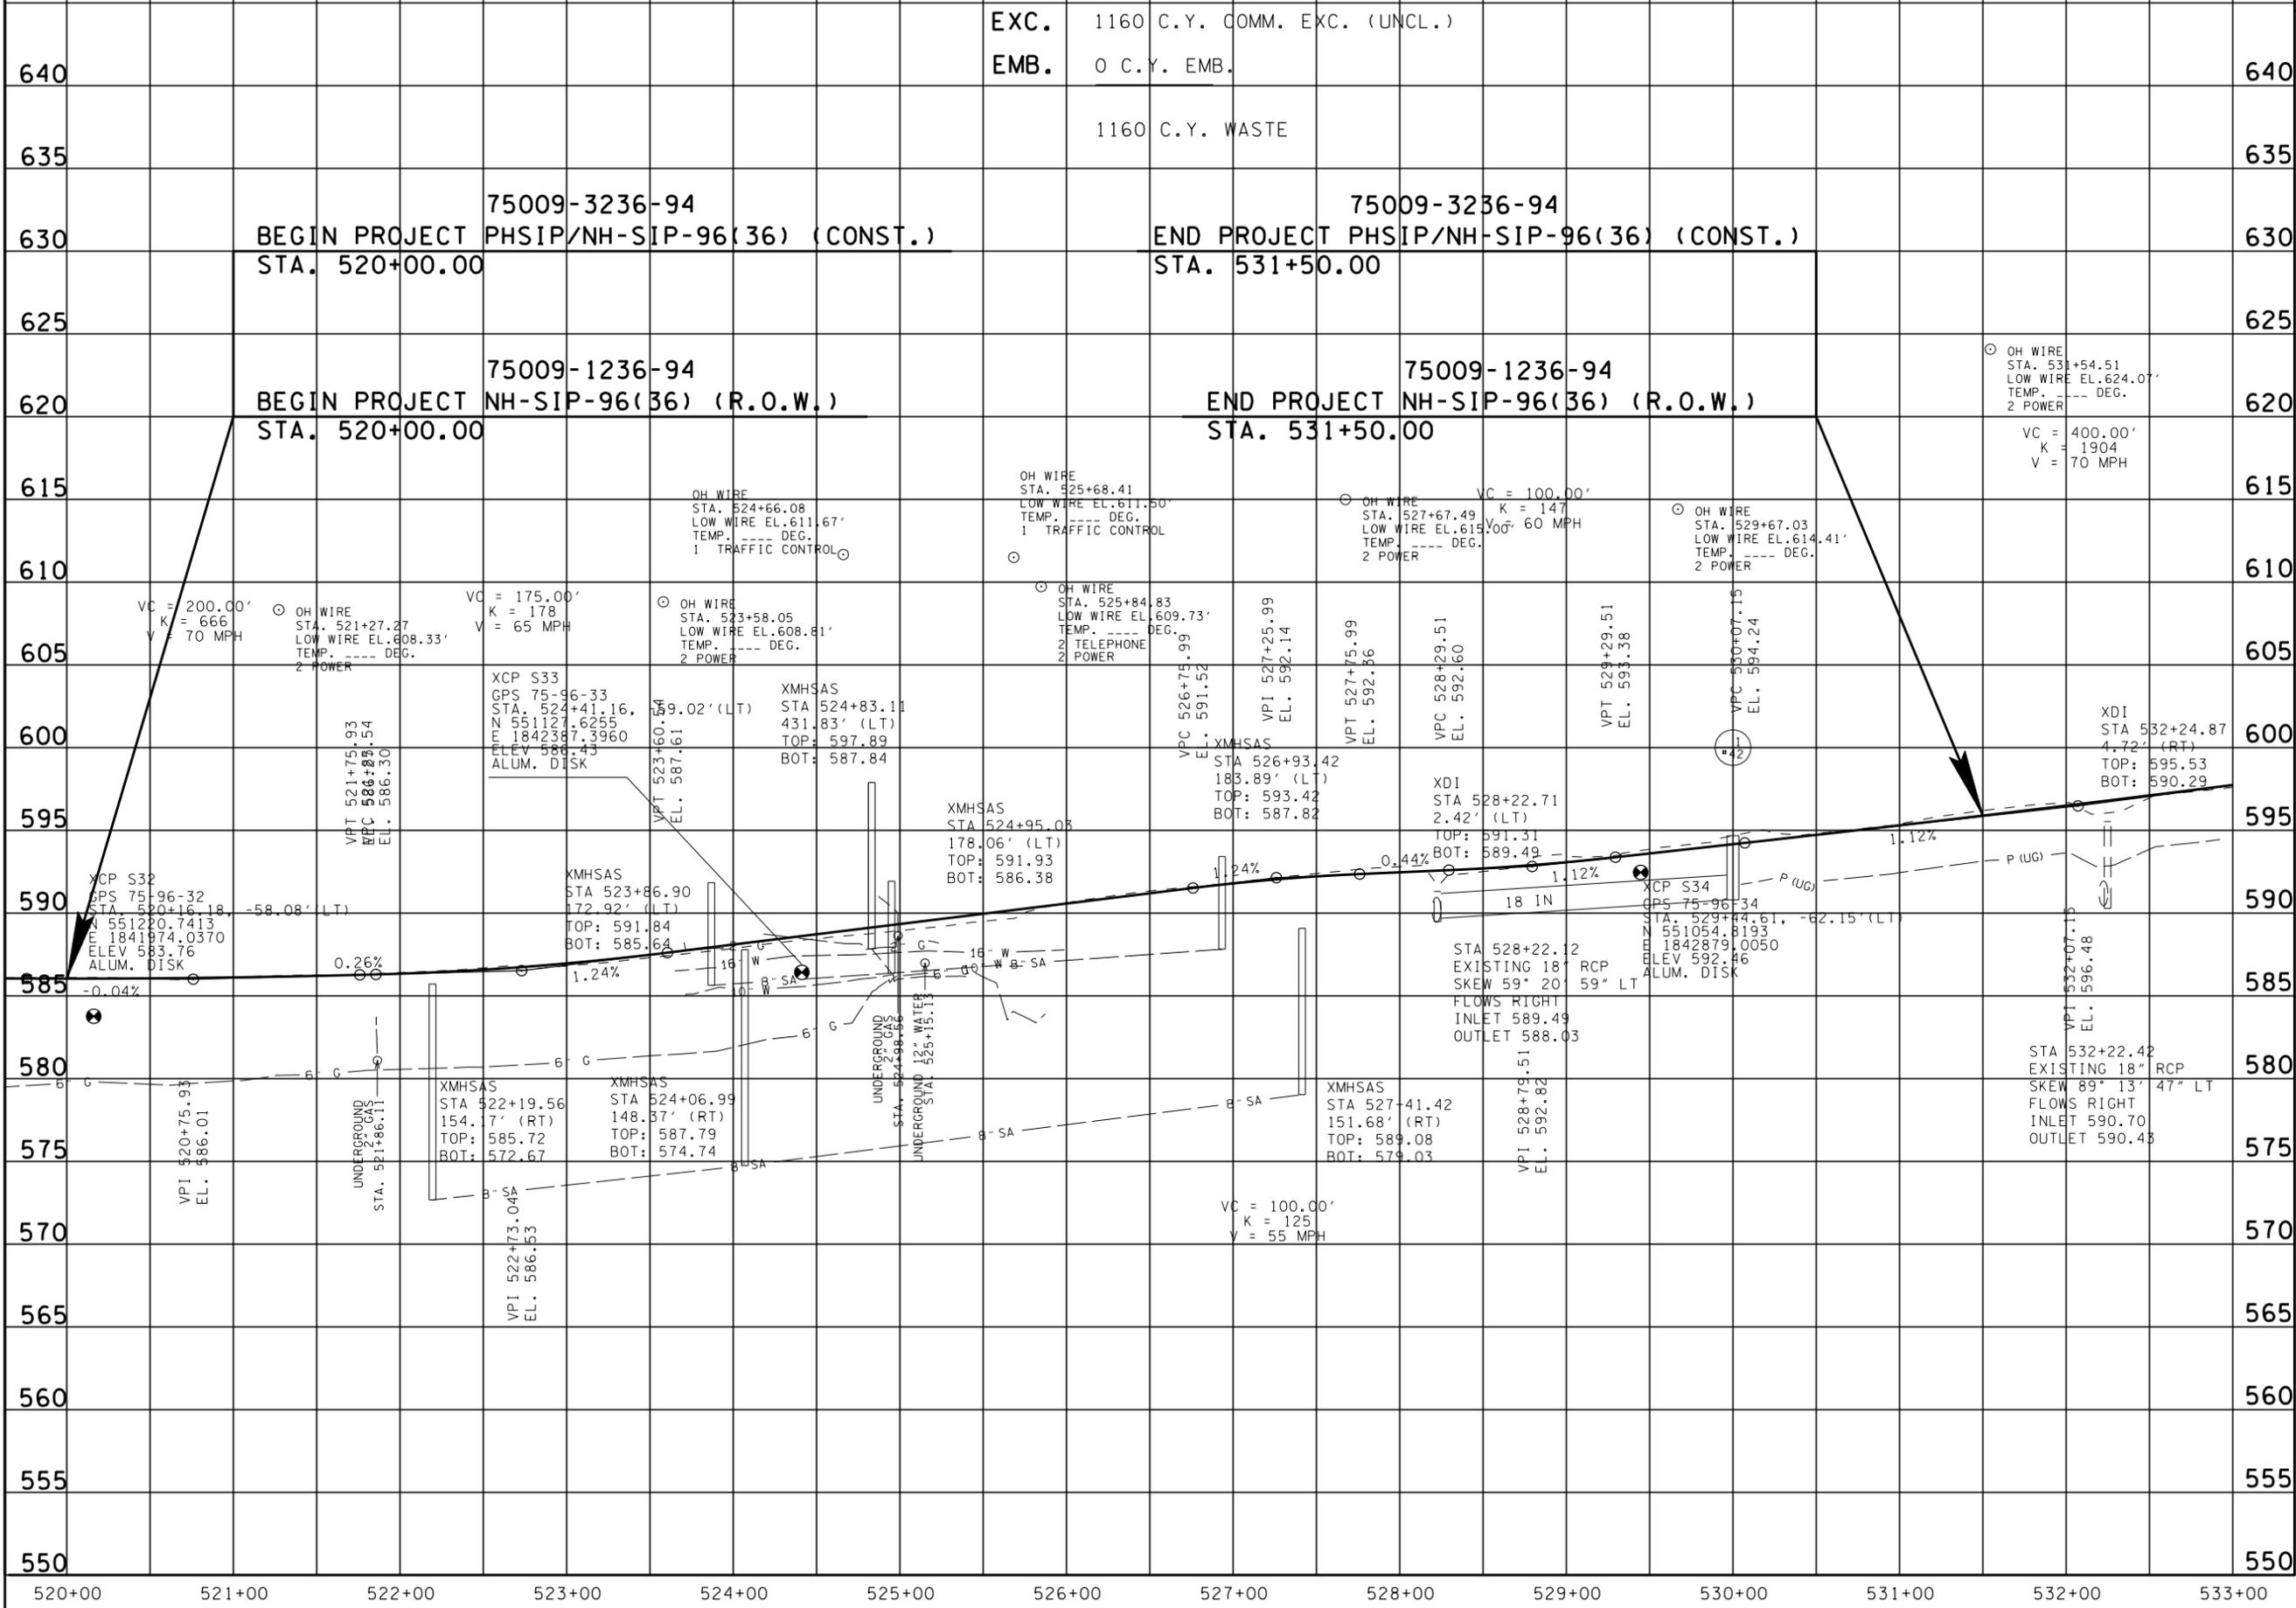
**PROPOSED
 LAYOUT**

STA. 520+00 TO STA. 531+50

SCALE: 1" = 50'

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TYPE	YEAR	PROJECT NO.	SHEET NO.
R.O.W.	2014	NH-SIP-96(36)	48
CONST.	2014	PHSIP/NH-SIP-96(36)	48



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PROFILE

STA. 520+00 TO STA. 531+50
 SCALE: 1" = 50' HORIZ.
 1" = 5' VERT.

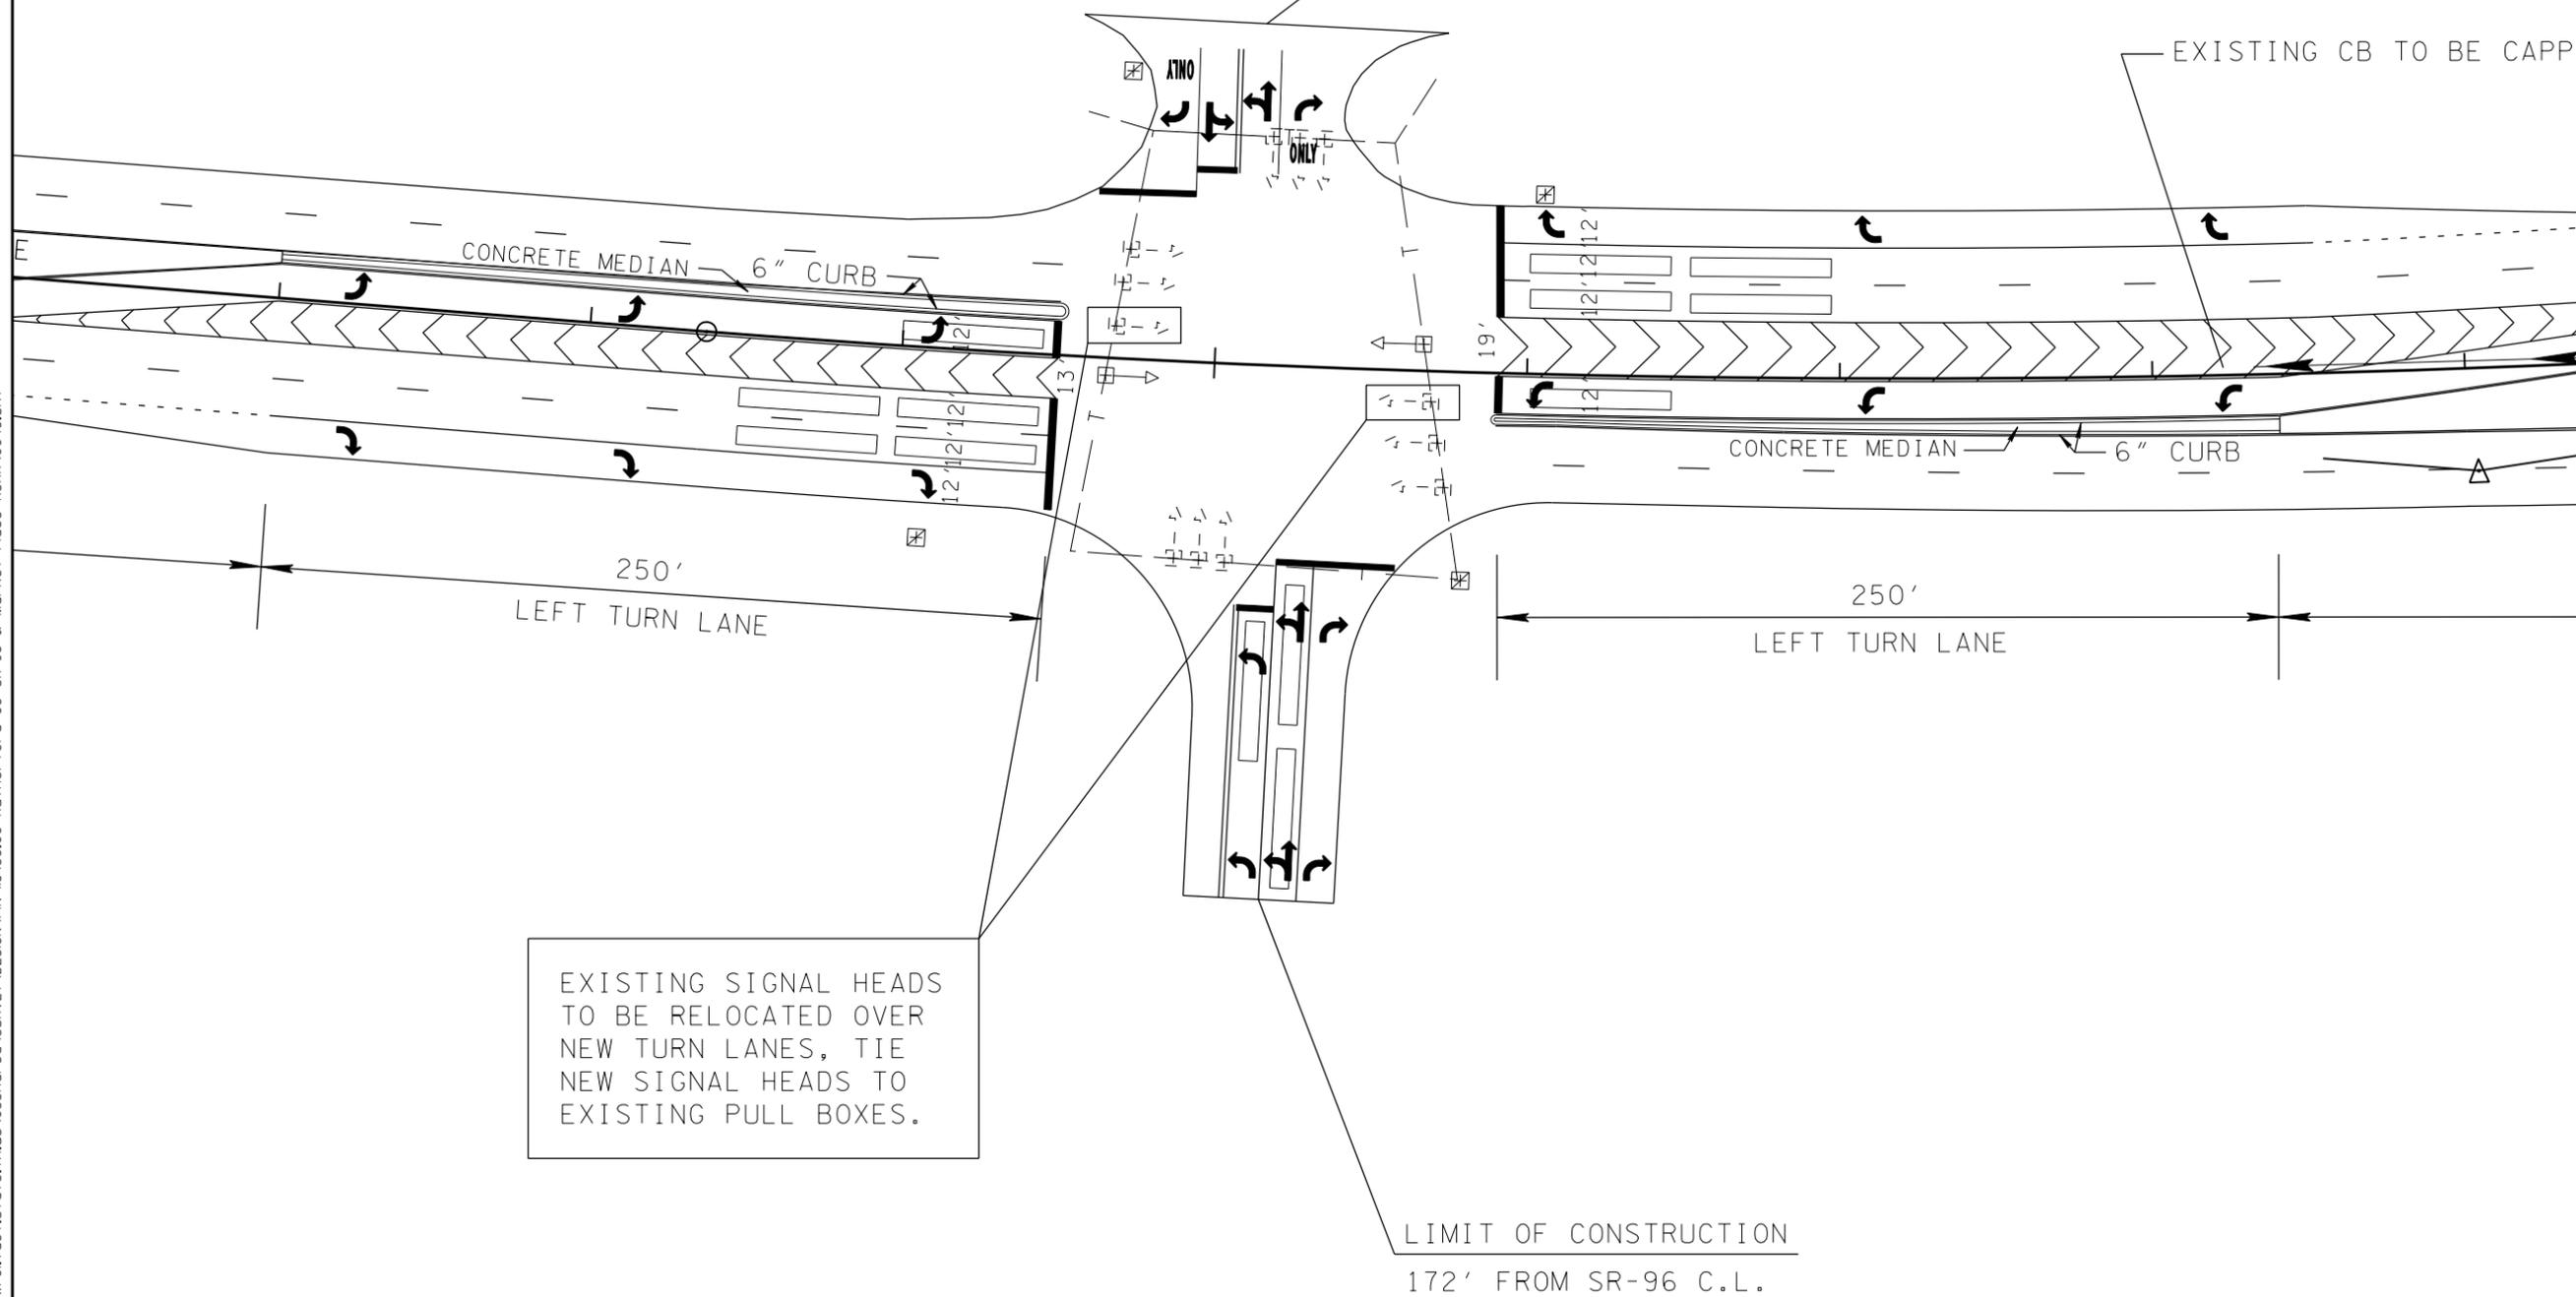
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TYPE	YEAR	PROJECT NO.	SHEET NO.
CONST.	2014	PHSIP/NH-SIP-96(36)	4C

525

LIMIT OF CONSTRUCTION
110' FROM SR-96 C.L.

EXISTING CB TO BE CAPPE



EXISTING SIGNAL HEADS
TO BE RELOCATED OVER
NEW TURN LANES, TIE
NEW SIGNAL HEADS TO
EXISTING PULL BOXES.

LIMIT OF CONSTRUCTION
172' FROM SR-96 C.L.

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**SIGNAL
DETAIL**

SR-96 @ MARKET ST.

SCALE: 1" = 30'

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TYPE	YEAR	PROJECT NO.	SHEET NO.
CONST.	2014	PHSIP/NH-SIP-96(36)	5

EROSION PREVENTION AND SEDIMENT CONTROL NOTES

NPDES

- (1) NO WORK SHALL BE STARTED UNTIL THE CONTRACTOR'S PLAN FOR THE STAGING OF THEIR OPERATIONS, INCLUDING THE PLAN FOR STAGING OF TEMPORARY AND PERMANENT EPSC MEASURES, HAS BEEN ACCEPTED BY THE ENGINEER. THE CONTRACTOR'S EPSC PLAN SHALL INCORPORATE AND SUPPLEMENT, AS ACCEPTABLE, THE BASIC EPSC DEVICES ON THE EPSC PLAN CONTAINED IN THE APPROVED SWPPP.
- (2) THE EPSC MEASURES AND/OR PLAN SHALL BE MODIFIED AS NECESSARY SO THAT THEY ARE EFFECTIVE AT ALL TIMES THROUGHOUT THE COURSE OF THE PROJECT.
- (3) THE ACCEPTED EPSC PLAN SHALL REQUIRE THAT EPSC MEASURES BE IN PLACE BEFORE CLEARING, GRUBBING, EXCAVATION, GRADING, CUTTING OR FILLING OCCURS, EXCEPT AS SUCH WORK MAY BE NECESSARY TO INSTALL EPSC MEASURES, INCLUDING WITHOUT LIMITATION AS FOLLOWS:
 - A. INITIAL CLEARING AND GRUBBING SHALL BE LIMITED TO THAT NECESSARY FOR THE INSTALLATION OF APPLICABLE EPSC MEASURES IN ACCORDANCE WITH THE ACCEPTED EPSC PLAN INCORPORATED INTO THE SWPPP.
 - B. NO OTHER CLEARING AND GRUBBING OPERATIONS SHALL BE STARTED BEFORE APPLICABLE EPSC MEASURES ARE IN PLACE IN ACCORDANCE WITH THE ACCEPTED EPSC PLAN INCORPORATED INTO THE SWPPP.
 - C. NO CULVERT OR BRIDGE CONSTRUCTION SHALL BE STARTED BEFORE APPLICABLE EPSC MEASURES ARE IN PLACE IN ACCORDANCE WITH THE ACCEPTED EPSC PLAN INCORPORATED INTO THE SWPPP.
 - D. NO GRADING, EXCAVATION, CUTTING, FILLING, OR OTHER EARTHWORK SHALL BE STARTED BEFORE EPSC MEASURES ARE IN PLACE IN ACCORDANCE WITH THE ACCEPTED EPSC PLAN INCORPORATED INTO THE SWPPP.
- (4) PERMANENT EPSC MEASURES SHALL BE INITIATED WITHIN 14 CALENDAR DAYS AFTER FINAL GRADING OF ANY SEQUENCE OR PHASE. TEMPORARY OR PERMANENT STABILIZATION SHALL BE INITIATED WITHIN 14 CALENDAR DAYS AFTER FINAL GRADING OR WHEN CONSTRUCTION ACTIVITIES ON A PORTION OF THE SITE ARE TEMPORARILY CEASED AND EARTH DISTURBING ACTIVITIES WILL NOT RESUME UNTIL AFTER 14 CALENDAR DAYS. PERMANENT STABILIZATION WITH PERENNIAL VEGETATION OR OTHER PERMANENTLY STABLE NON-ERODING SURFACE SHALL REPLACE ANY TEMPORARY MEASURES AS SOON AS PRACTICABLE. UNPACKED GRAVEL CONTAINING FINES (SILT AND CLAY SIZED PARTICLES) OR CRUSHER-RUN WILL NOT BE CONSIDERED A NON-ERODIBLE SURFACE.
- (5) STEEP SLOPES (A NATURAL OR CREATED SLOPE OF 35% GRADE (2.8H:1V) OR GREATER REGARDLESS OF HEIGHT) SHALL BE TEMPORARILY STABILIZED NO LATER THAN 7 CALENDAR DAYS AFTER CONSTRUCTION ACTIVITY ON THE SLOPE HAS TEMPORARILY OR PERMANENTLY CEASED.
- (6) FOR STORMWATER DISCHARGES ASSOCIATED WITH CONSTRUCTION SUPPORT ACTIVITIES; TDOT PROJECTS ARE COVERED UNDER THE "WASTE AND BORROW" MANUAL PER THE SSWMP.
- (7) EXCEPT AS OTHERWISE SPECIFIED, THERE ARE NO KNOWN SPECIAL ENVIRONMENTAL FACTORS PRESENT ON THIS PROJECT THAT INDICATE A NEED FOR SEASONAL LIMITATIONS ON THE CLEARING, GRUBBING, EXCAVATION, GRADING, CUTTING OR FILLING OPERATIONS OR ON THE TOTAL AREA OF EXPOSED SOIL.

EROSION PREVENTION AND SEDIMENT CONTROL QUANTITIES			
ITEM NO.	DESCRIPTION	UNIT	QUANTITY
209-03.20	FILTER SOCK (8 INCH)	L.F.	100
209-08.03	TEMPORARY SILT FENCE (WITHOUT BACKING)	L.F.	700
209-40.33	CATCH BASIN PROTECTION (TYPE D)	EACH	2

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**EROSION
PREVENTION
AND SEDIMENT
CONTROL PLAN**

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TYPE	YEAR	PROJECT NO.	SHEET NO.
R.O.W.	2014	NH-SIP-96(36)	5
CONST.	2014	PHSIP/NH-SIP-96(36)	6

75009-3236-94
 BEGIN PROJECT PHSIP/NH-SIP-96(36) (CONST.)
 STA. 520+00.00

75009-3236-94
 END PROJECT PHSIP/NH-SIP-96(36) (CONST.)
 STA. 531+50.00

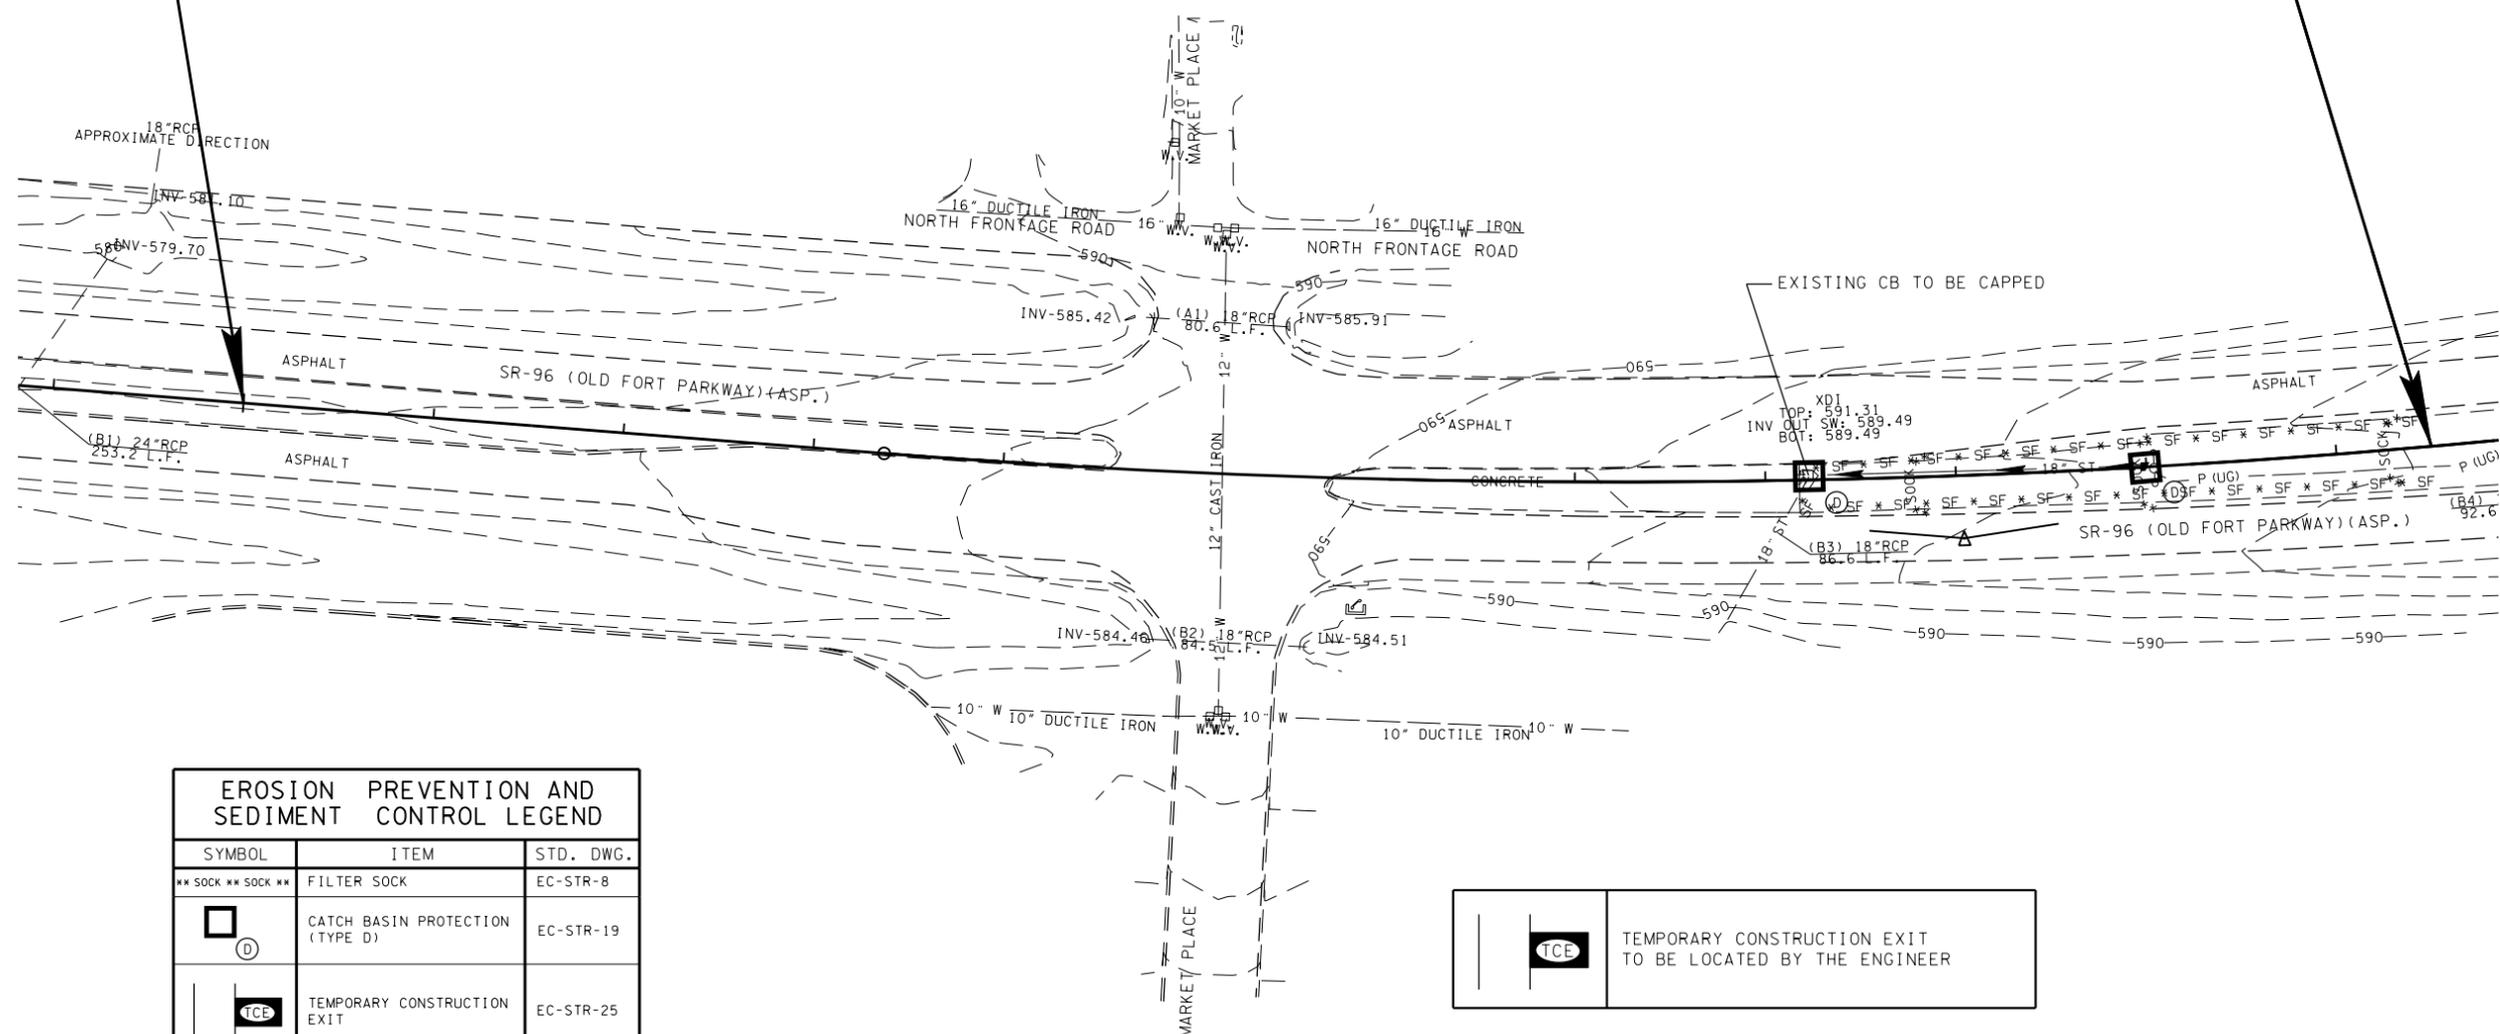
75009-1236-94
 BEGIN PROJECT NH-SIP-96(36) (R.O.W.)
 STA. 520+00.00

75009-1236-94
 END PROJECT NH-SIP-96(36) (R.O.W.)
 STA. 531+50.00

520

525

530



EROSION PREVENTION AND SEDIMENT CONTROL LEGEND		
SYMBOL	ITEM	STD. DWG.
** SOCK ** SOCK **	FILTER SOCK	EC-STR-8
	CATCH BASIN PROTECTION (TYPE D)	EC-STR-19
	TEMPORARY CONSTRUCTION EXIT	EC-STR-25

	TEMPORARY CONSTRUCTION EXIT TO BE LOCATED BY THE ENGINEER
--	---

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**EROSION
 PREVENTION
 AND SEDIMENT
 CONTROL PLAN**

STA. 520+00 TO STA. 531+50
 SCALE: 1" = 50'

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TYPE	YEAR	PROJECT NO.	SHEET NO.
R.O.W.	2014	NH-SIP-96(36)	5
CONST.	2014	PHSIP/NH-SIP-96(36)	7

75009-3236-94
 BEGIN PROJECT PHSIP/NH-SIP-96(36) (CONST.)
 STA. 520+00.00

75009-3236-94
 END PROJECT PHSIP/NH-SIP-96(36) (CONST.)
 STA. 531+50.00

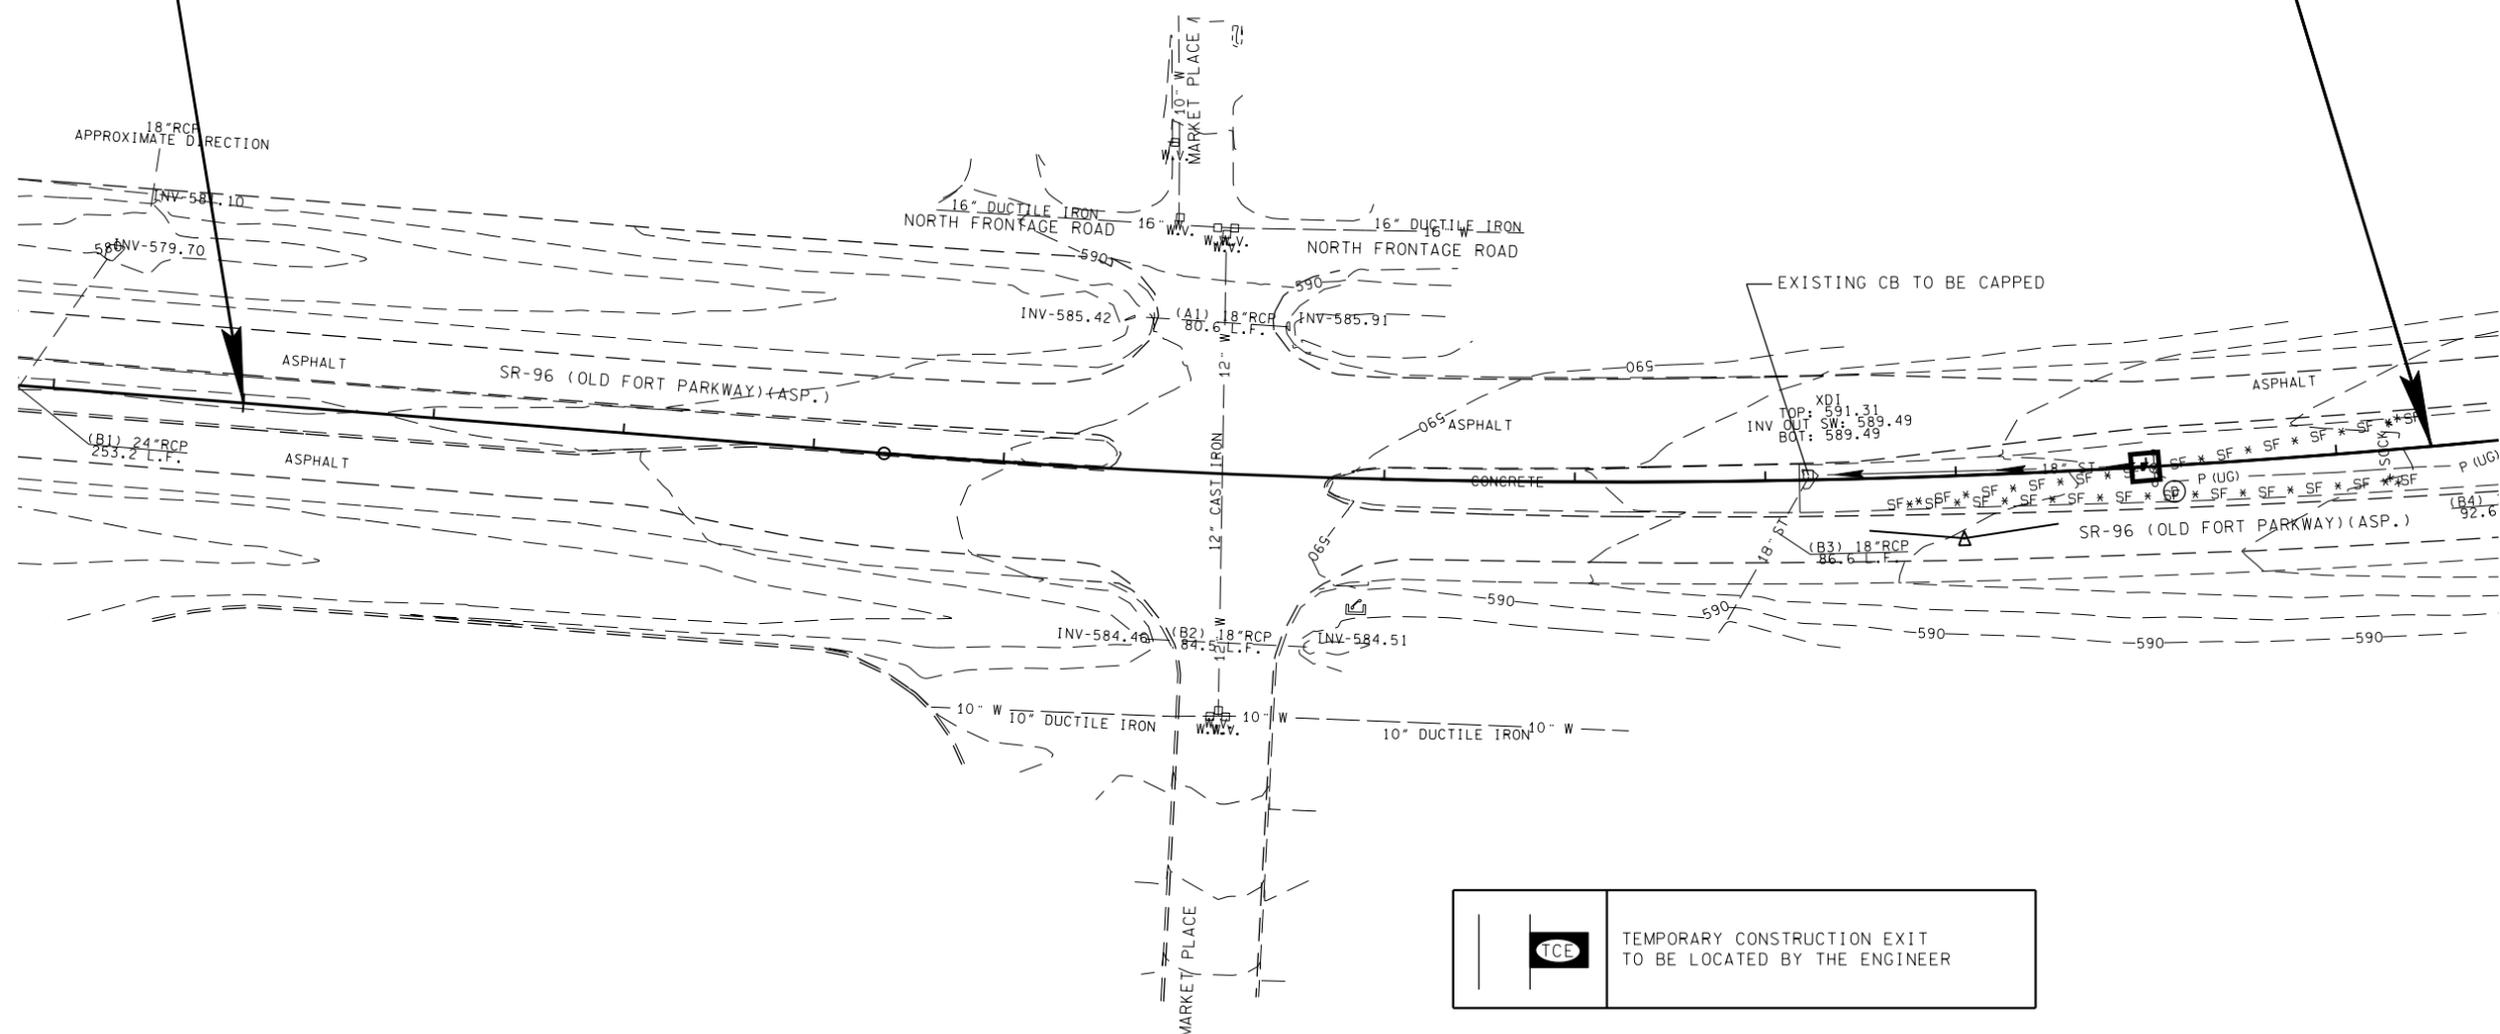
75009-1236-94
 BEGIN PROJECT NH-SIP-96(36) (R.O.W.)
 STA. 520+00.00

75009-1236-94
 END PROJECT NH-SIP-96(36) (R.O.W.)
 STA. 531+50.00

520

525

530



TCE TEMPORARY CONSTRUCTION EXIT TO BE LOCATED BY THE ENGINEER

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EROSION PREVENTION AND SEDIMENT CONTROL PLAN

STA. 520+00 TO STA. 531+50
 SCALE: 1" = 50'

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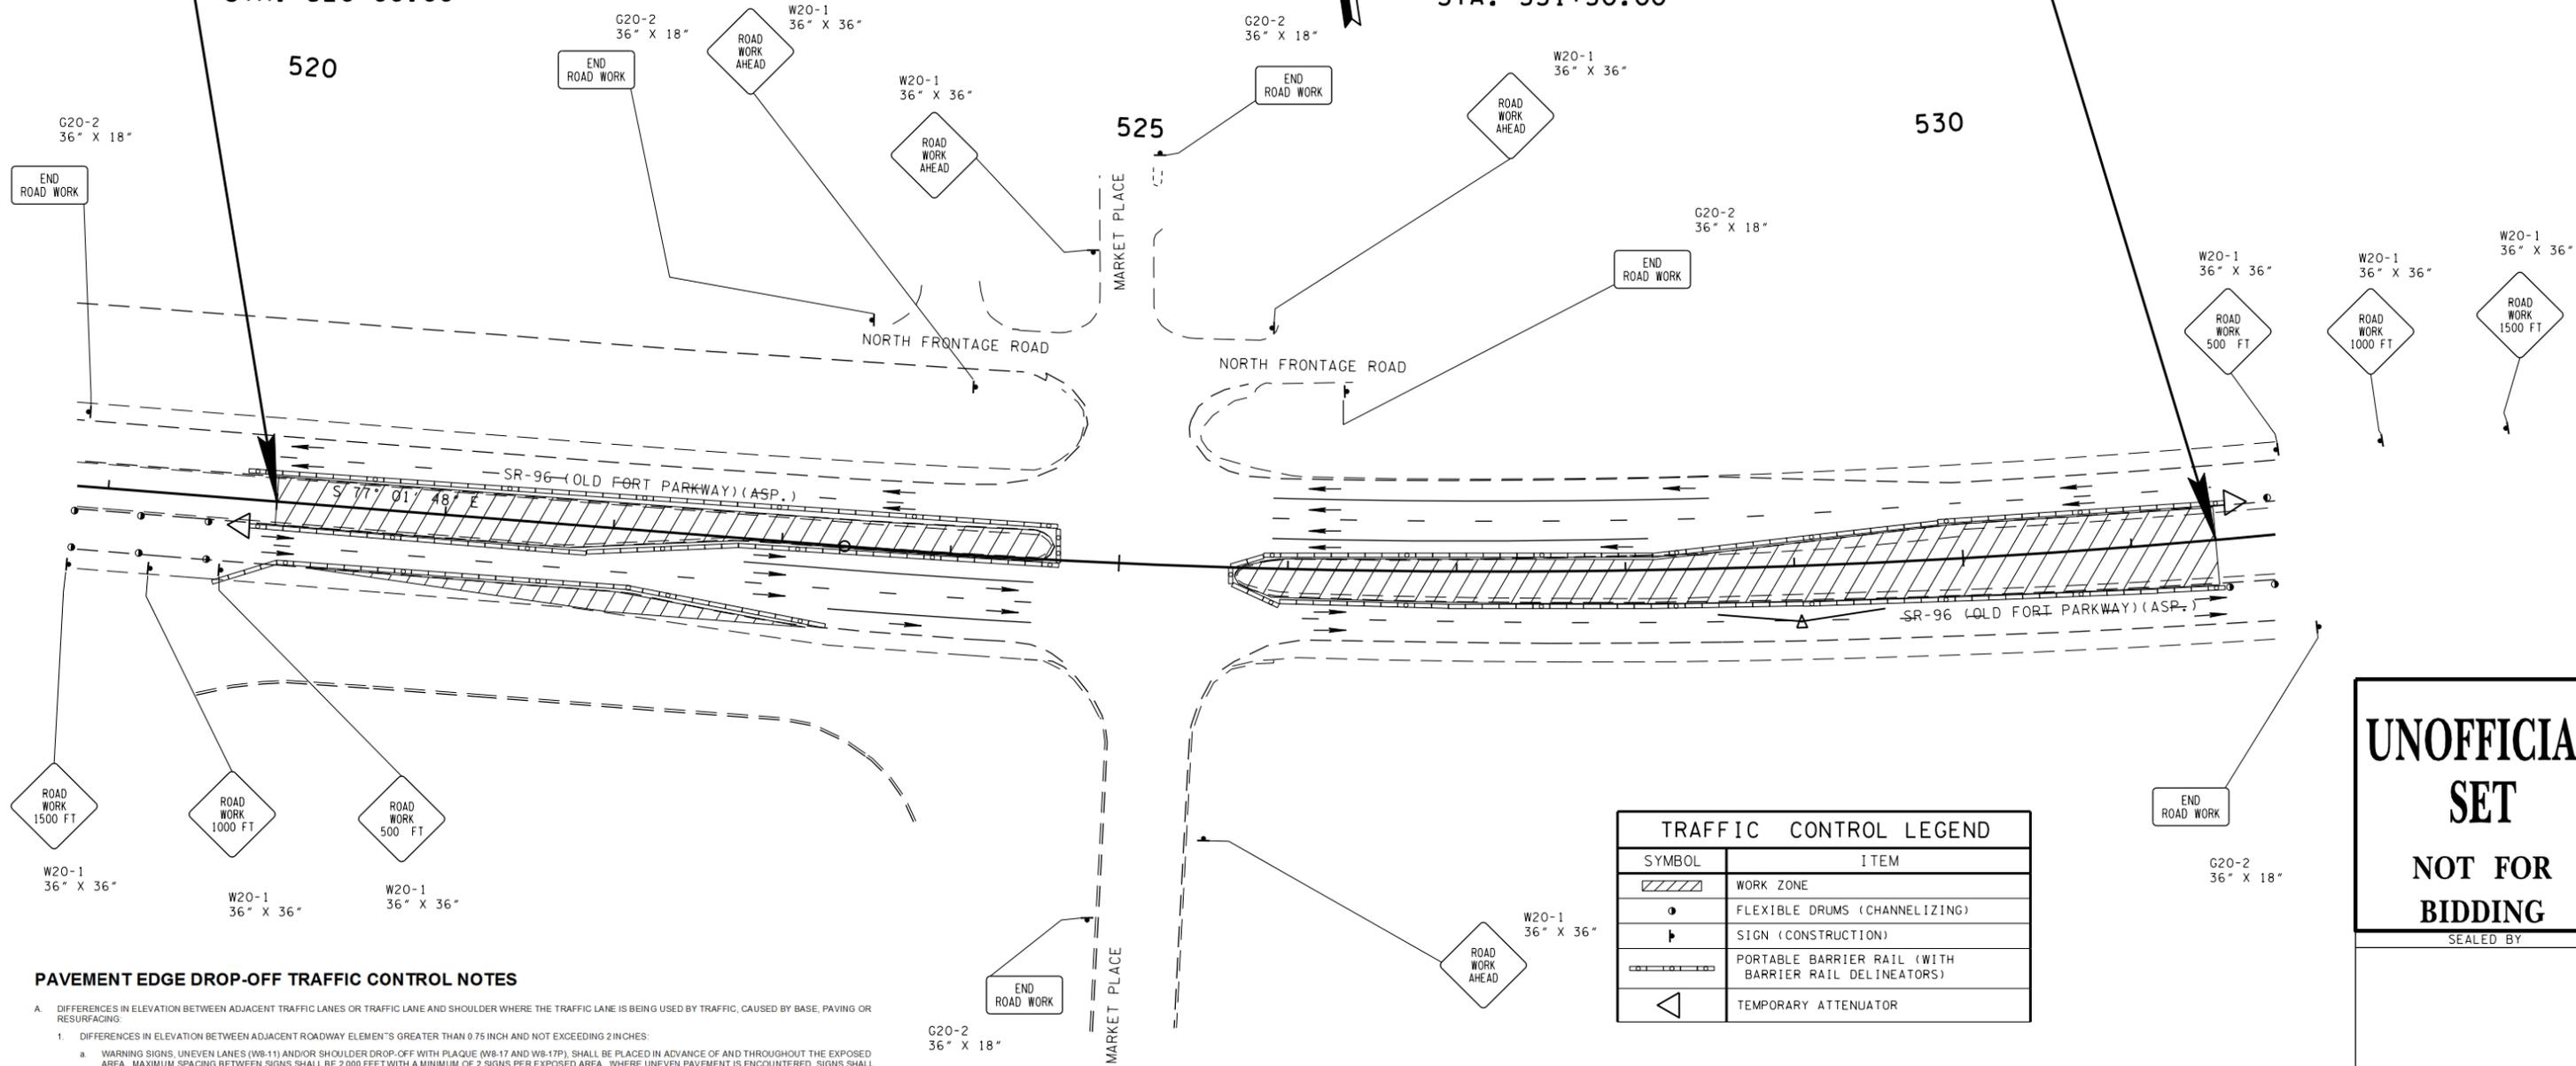
TYPE	YEAR	PROJECT NO.	SHEET NO.
R.O.W.	2014	NH-SIP-96(36)	5A
CONST.	2014	PHSIP/NH-SIP-96(36)	8

75009-3236-94
 BEGIN PROJECT PHSIP/NH-SIP-96(36) (CONST.)
 STA. 520+00.00

75009-3236-94
 END PROJECT PHSIP/NH-SIP-96(36) (CONST.)
 STA. 531+50.00

75009-1236-94
 BEGIN PROJECT NH-SIP-96(36) (R.O.W.)
 STA. 520+00.00

75009-1236-94
 END PROJECT NH-SIP-96(36) (R.O.W.)
 STA. 531+50.00



PAVEMENT EDGE DROP-OFF TRAFFIC CONTROL NOTES

- A. DIFFERENCES IN ELEVATION BETWEEN ADJACENT TRAFFIC LANES OR TRAFFIC LANE AND SHOULDER WHERE THE TRAFFIC LANE IS BEING USED BY TRAFFIC, CAUSED BY BASE, PAVING OR RESURFACING.
 - 1. DIFFERENCES IN ELEVATION BETWEEN ADJACENT ROADWAY ELEMENTS GREATER THAN 0.75 INCH AND NOT EXCEEDING 2 INCHES:
 - a. WARNING SIGNS, UNEVEN LANES (W8-11) AND/OR SHOULDER DROP-OFF WITH PLAQUE (W8-17 AND W8-17P), SHALL BE PLACED IN ADVANCE OF AND THROUGHOUT THE EXPOSED AREA. MAXIMUM SPACING BETWEEN SIGNS SHALL BE 2,000 FEET WITH A MINIMUM OF 2 SIGNS PER EXPOSED AREA. WHERE UNEVEN PAVEMENT IS ENCOUNTERED, SIGNS SHALL BE PLACED ON EACH SIDE OF THE ROADWAY.
 - b. DIFFERENCES IN ELEVATION BETWEEN ADJACENT TRAFFIC LANES BEING UTILIZED BY TRAFFIC CAUSED BY ADDED PAVEMENT SHALL BE ELIMINATED WITHIN THREE WORKDAYS.
 - c. DIFFERENCES IN ELEVATION BETWEEN ADJACENT TRAFFIC LANES BEING UTILIZED BY TRAFFIC CAUSED BY COLD PLANING SHALL BE ELIMINATED WITHIN THREE WORKDAYS.
 - d. WHEN THE DIFFERENCE IN ELEVATION IS BETWEEN THE TRAFFIC LANE BEING UTILIZED BY TRAFFIC AND SHOULDER THE DIFFERENCE IN ELEVATION SHALL BE ELIMINATED WITHIN SEVEN WORKDAYS AFTER THE CONDITION IS CREATED.
 - 2. IF THE DIFFERENCE IN ELEVATION IS WITHIN 8 FEET OF THE NEAREST TRAFFIC LANE WITH DIFFERENCE IN ELEVATION GREATER THAN 8 INCHES:
 - a. SEPARATION SHALL BE ACCOMPLISHED BY DRUMS, BARRICADES OR OTHER APPROVED DEVICES IN ACCORDANCE WITH THE FOLLOWING:
 - (1) WHERE POSTED SPEEDS ARE 50 MPH OR GREATER, SPACING OF THE PROTECTIVE DEVICES SHALL NOT EXCEED 100 FEET.
 - (2) WHERE POSTED SPEEDS ARE LESS THAN 50 MPH THE MAXIMUM SPACING OF THE PROTECTIVE DEVICES IN FEET SHALL NOT EXCEED TWICE THE POSTED SPEED IN MILES PER HOUR OR 50 FEET, WHICHEVER SPACING IS GREATER.
 - b. ELIMINATE VERTICAL OFFSET BY CONSTRUCTING A STONE WEDGE OR GRADING TO A 4:1 SLOPE, OR FLATTER, OR USE PORTABLE BARRIER RAIL.
- THE CONTRACTOR SHALL SCHEDULE THE WORK SO AS TO MINIMIZE THE TIME TRAFFIC IS EXPOSED TO AN ELEVATION DIFFERENCE. ONCE THE CONTRACTOR BEGINS AN ACTIVITY THAT CREATES AN ELEVATION DIFFERENCE WITHIN 8 FEET OF A TRAFFIC LANE, THE ACTIVITY SHALL BE PURSUED AS A CONTINUOUS OPERATION UNTIL THE ELEVATION DIFFERENCE IS ELIMINATED.

TRAFFIC CONTROL LEGEND	
SYMBOL	ITEM
	WORK ZONE
	FLEXIBLE DRUMS (CHANNELIZING)
	SIGN (CONSTRUCTION)
	PORTABLE BARRIER RAIL (WITH BARRIER RAIL DELINEATORS)
	TEMPORARY ATTENUATOR

**UNOFFICIAL
 SET
 NOT FOR
 BIDDING**

SEALED BY

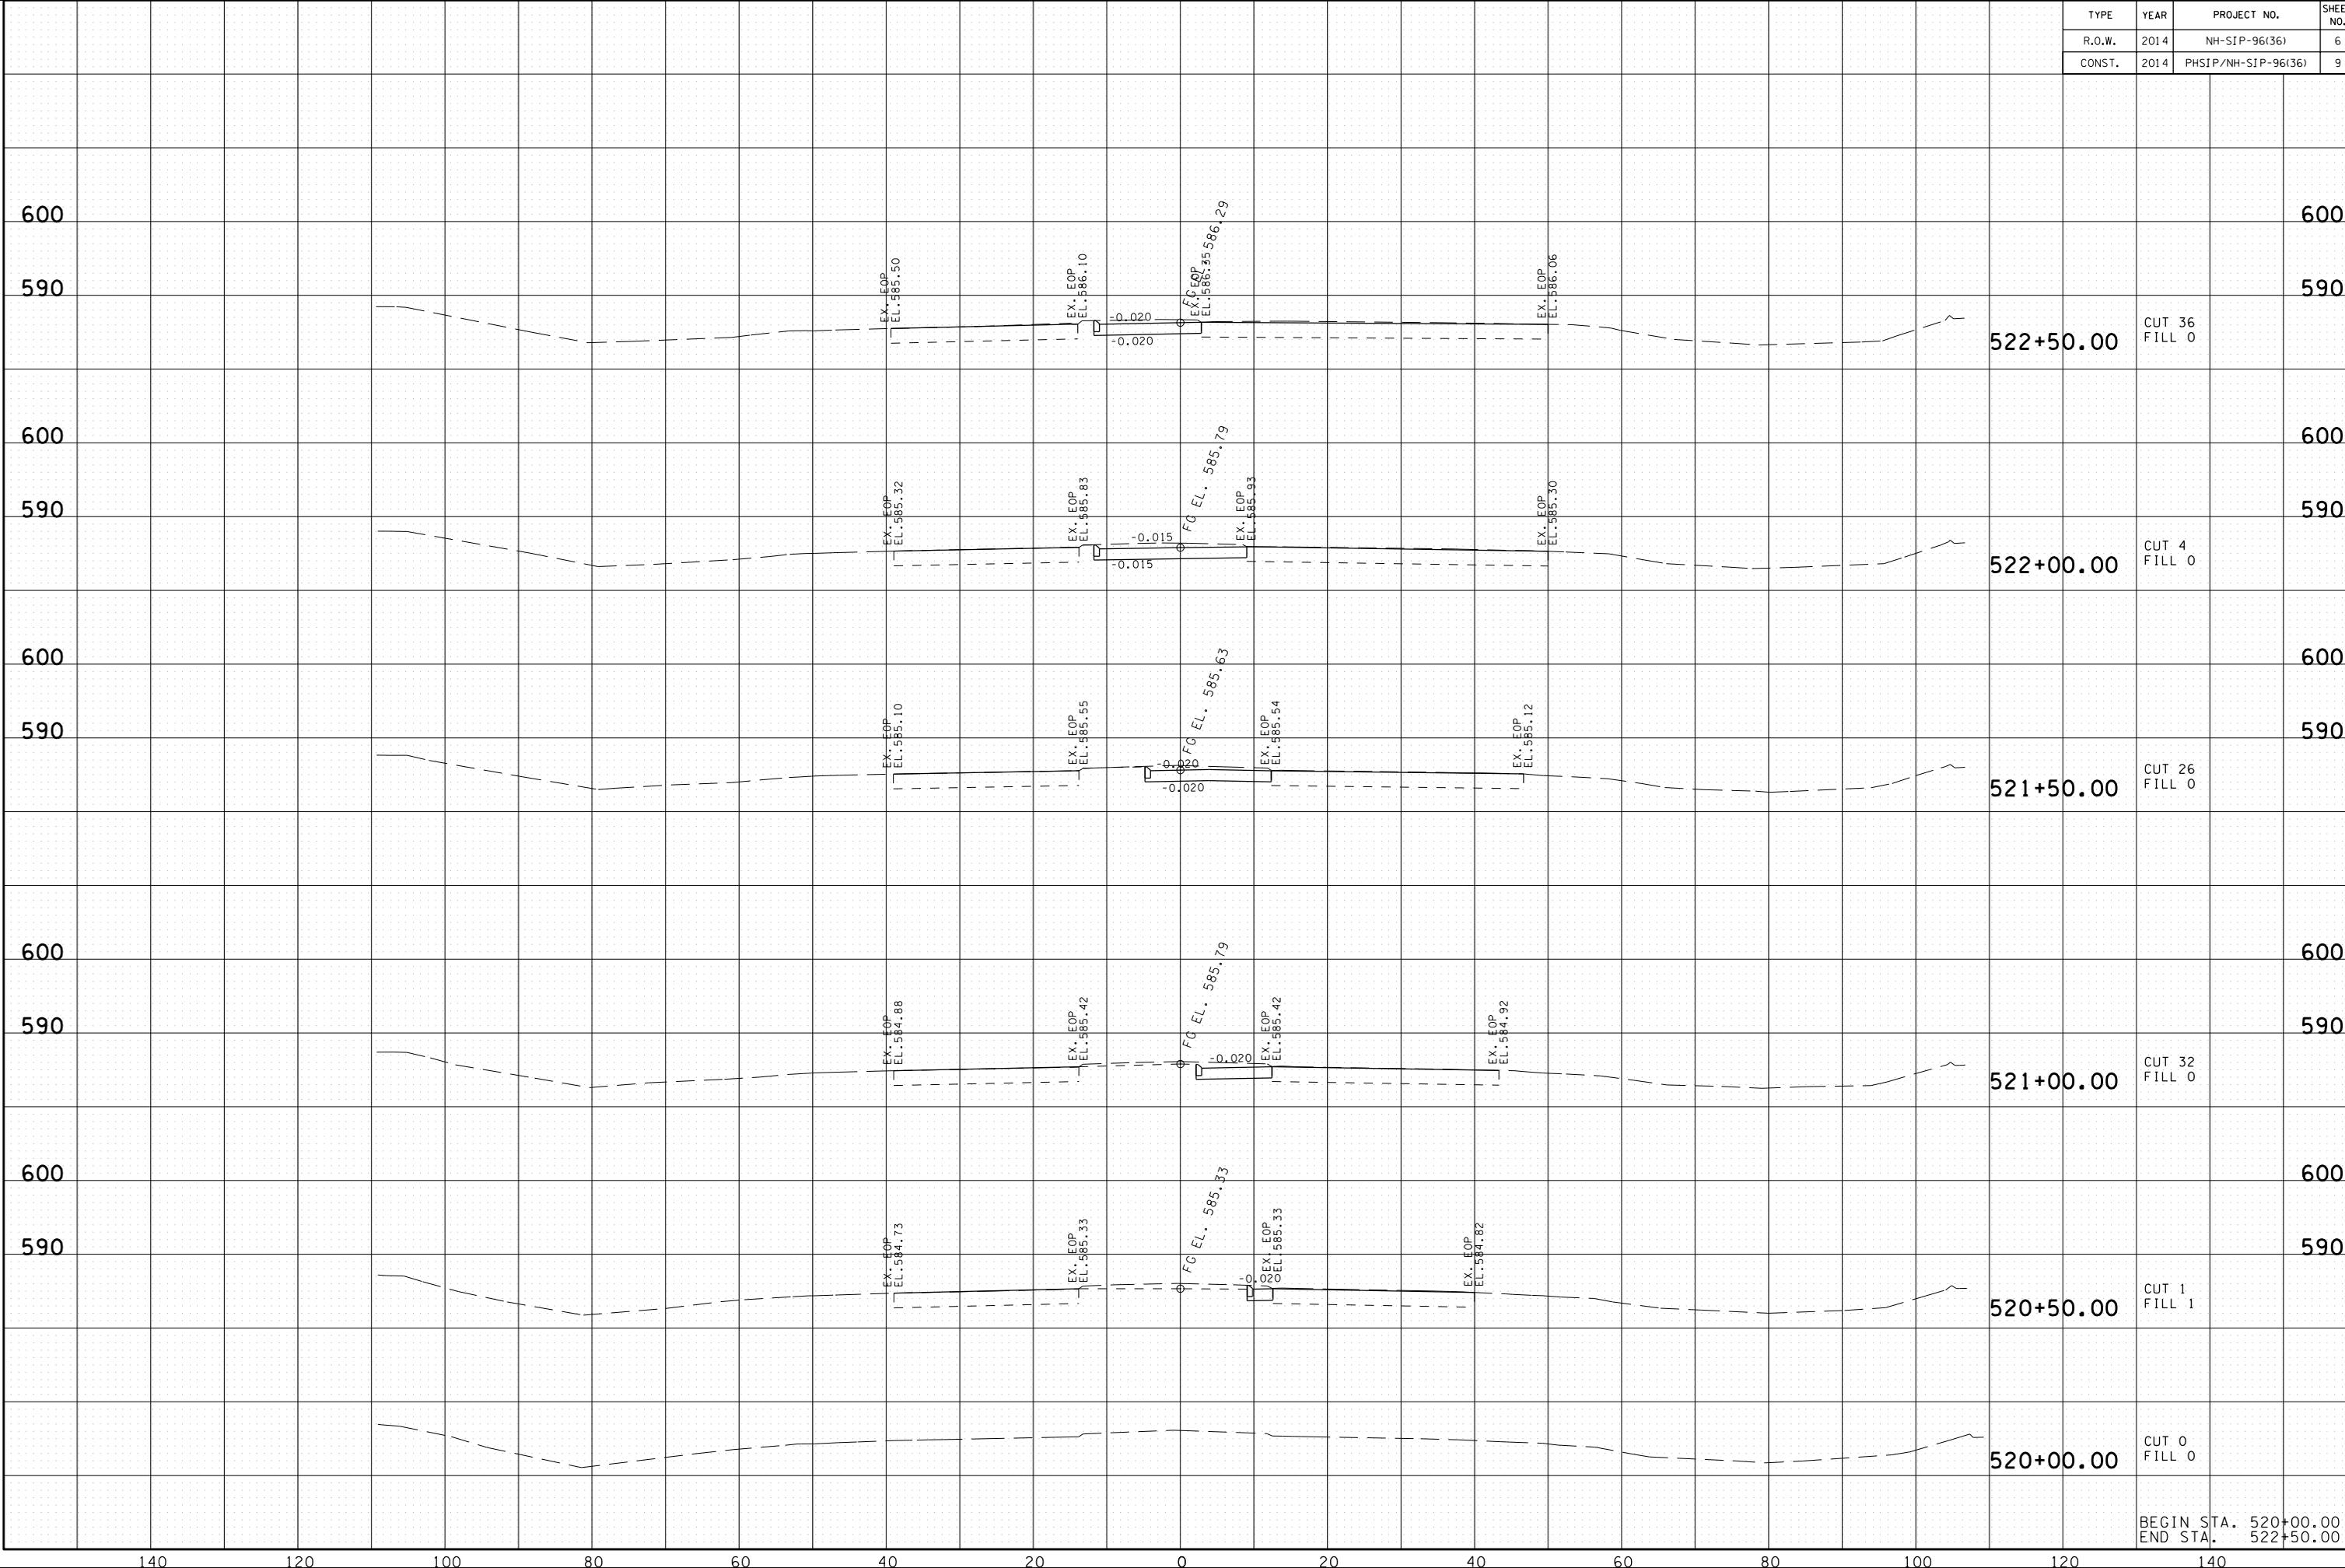
STATE OF TENNESSEE
 DEPARTMENT OF TRANSPORTATION

TRAFFIC CONTROL PLAN
 STA. 520+00 TO STA. 531+50
 SCALE: 1" = 50'

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TYPE	YEAR	PROJECT NO.	SHEET NO.
R.O.W.	2014	NH-SIP-96(36)	6
CONST.	2014	PHSIP/NH-SIP-96(36)	9

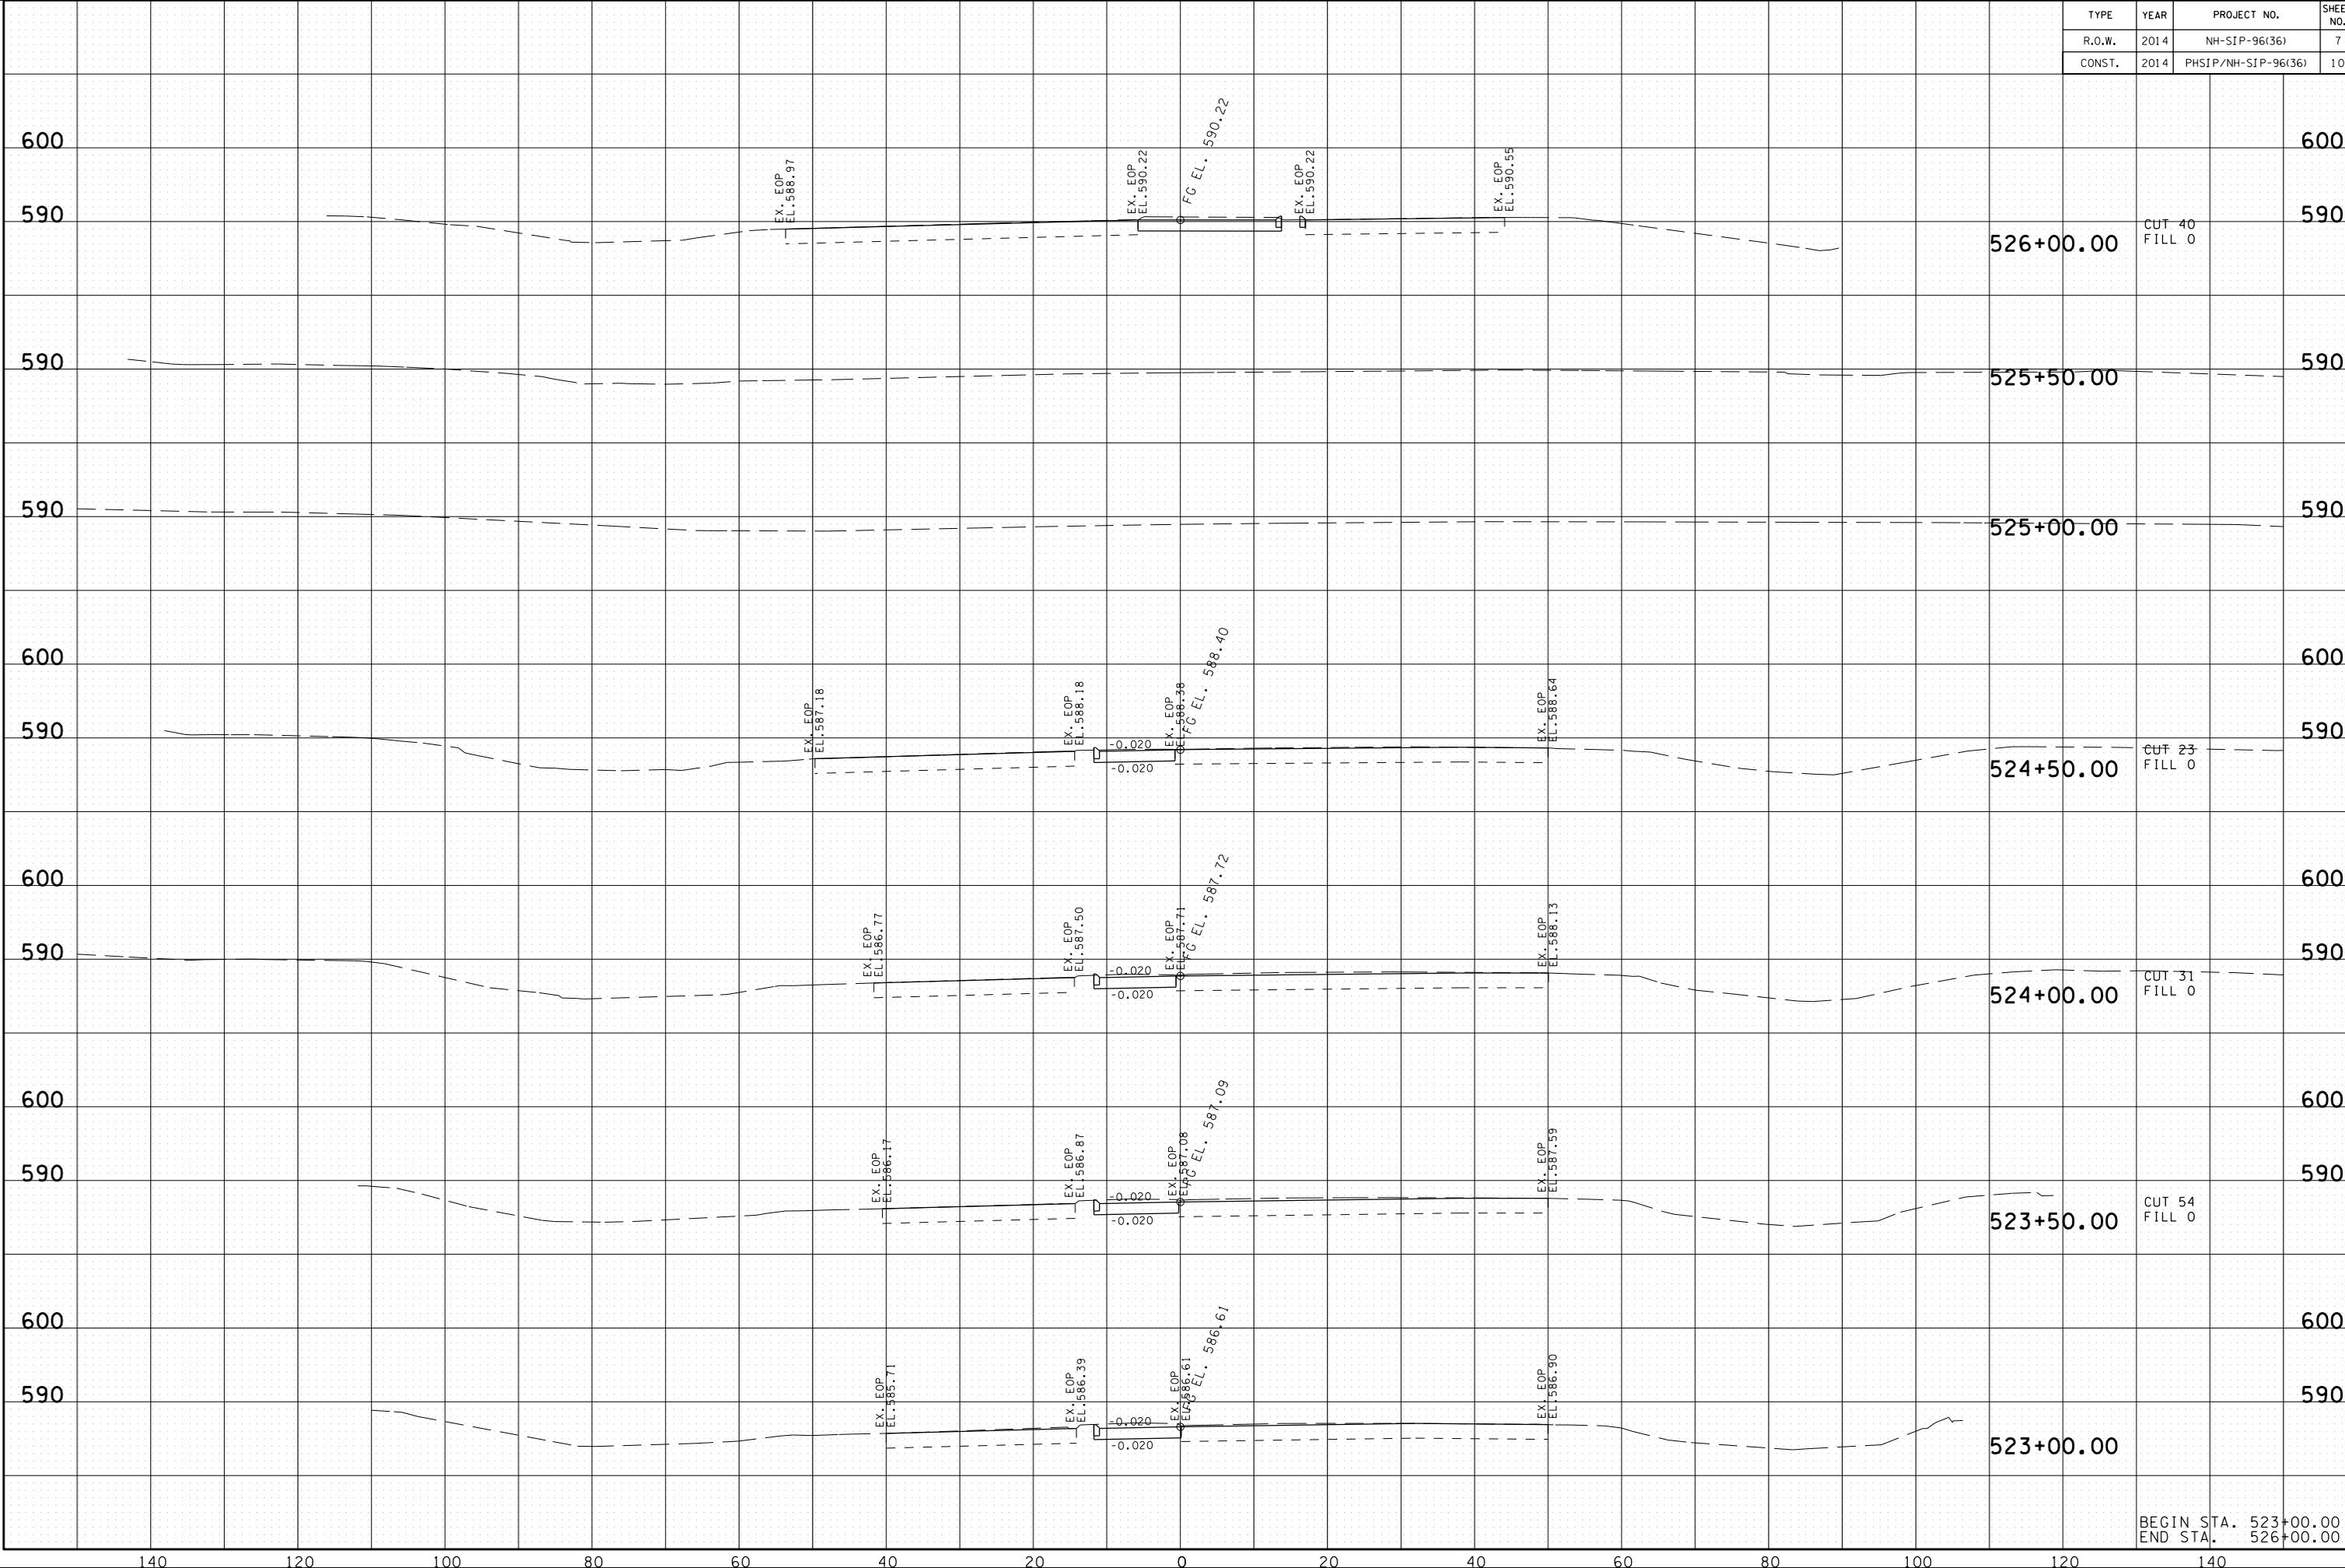
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BEGIN STA. 520+00.00
END STA. 522+50.00

TYPE	YEAR	PROJECT NO.	SHEET NO.
R.O.W.	2014	NH-SIP-96(36)	7
CONST.	2014	PHSIP/NH-SIP-96(36)	10

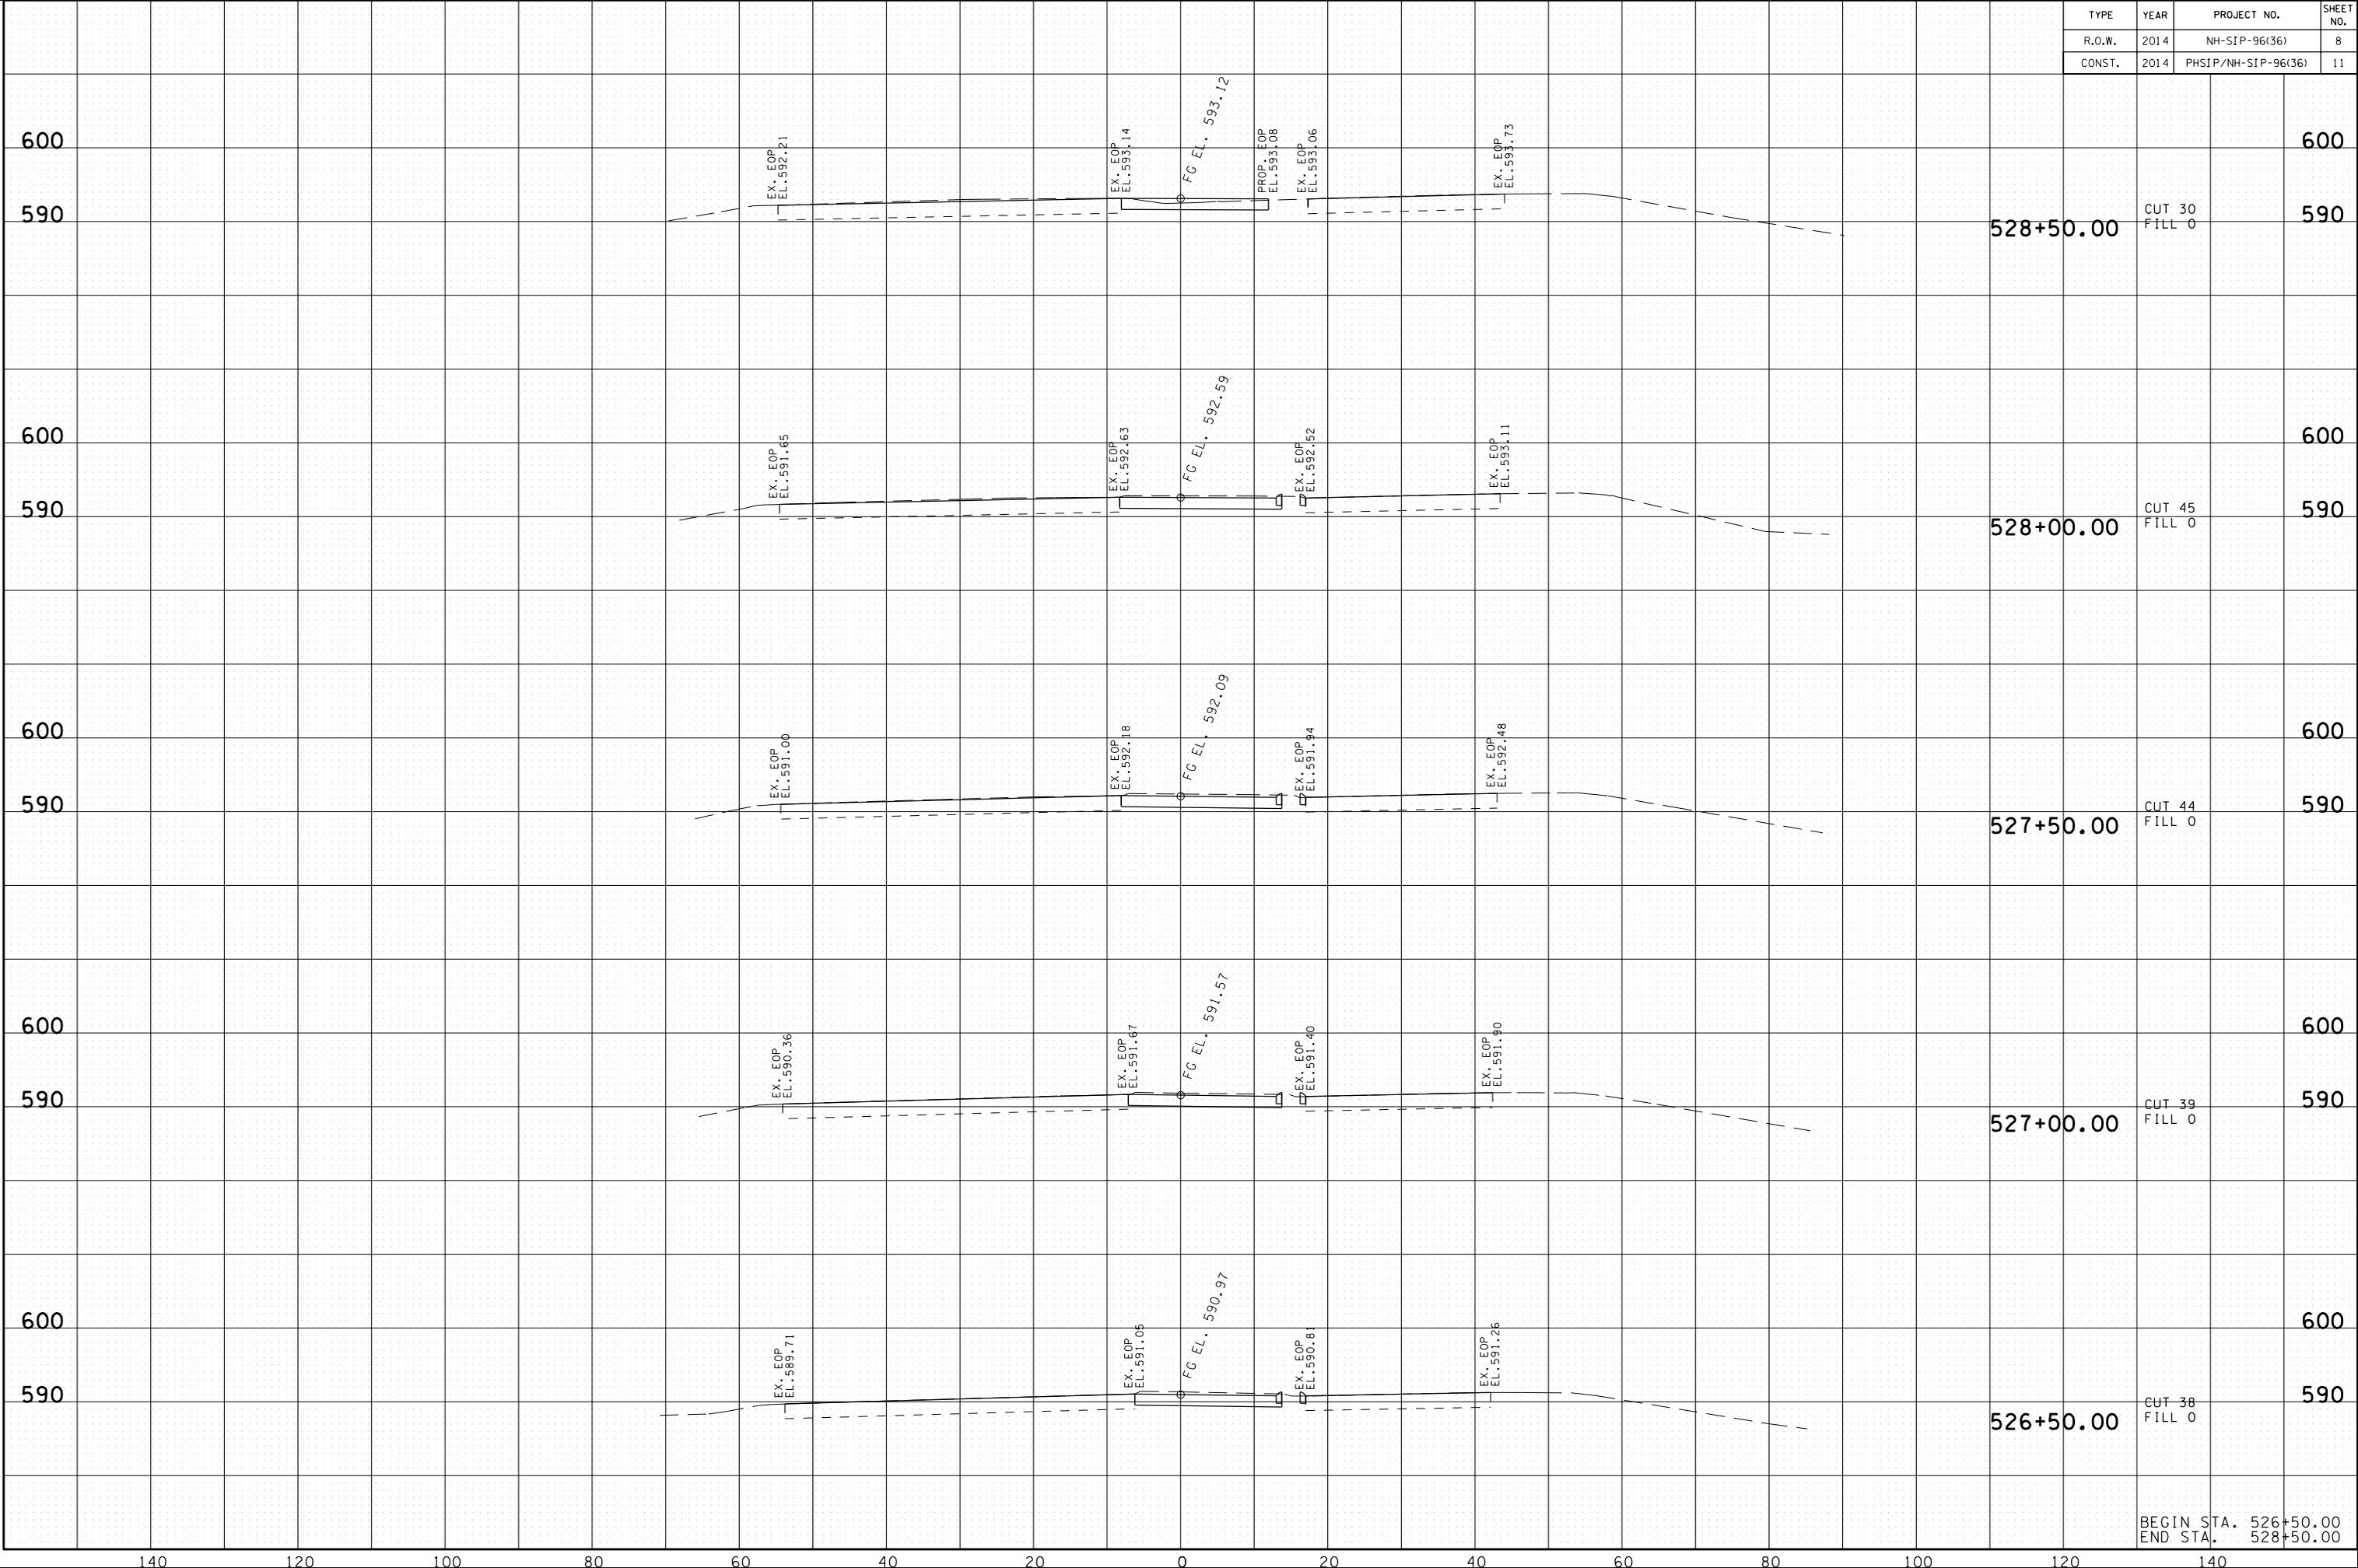
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BEGIN STA. 523+00.00
END STA. 526+00.00

TYPE	YEAR	PROJECT NO.	SHEET NO.
R.O.W.	2014	NH-SIP-96(36)	8
CONST.	2014	PHSIP/NH-SIP-96(36)	11

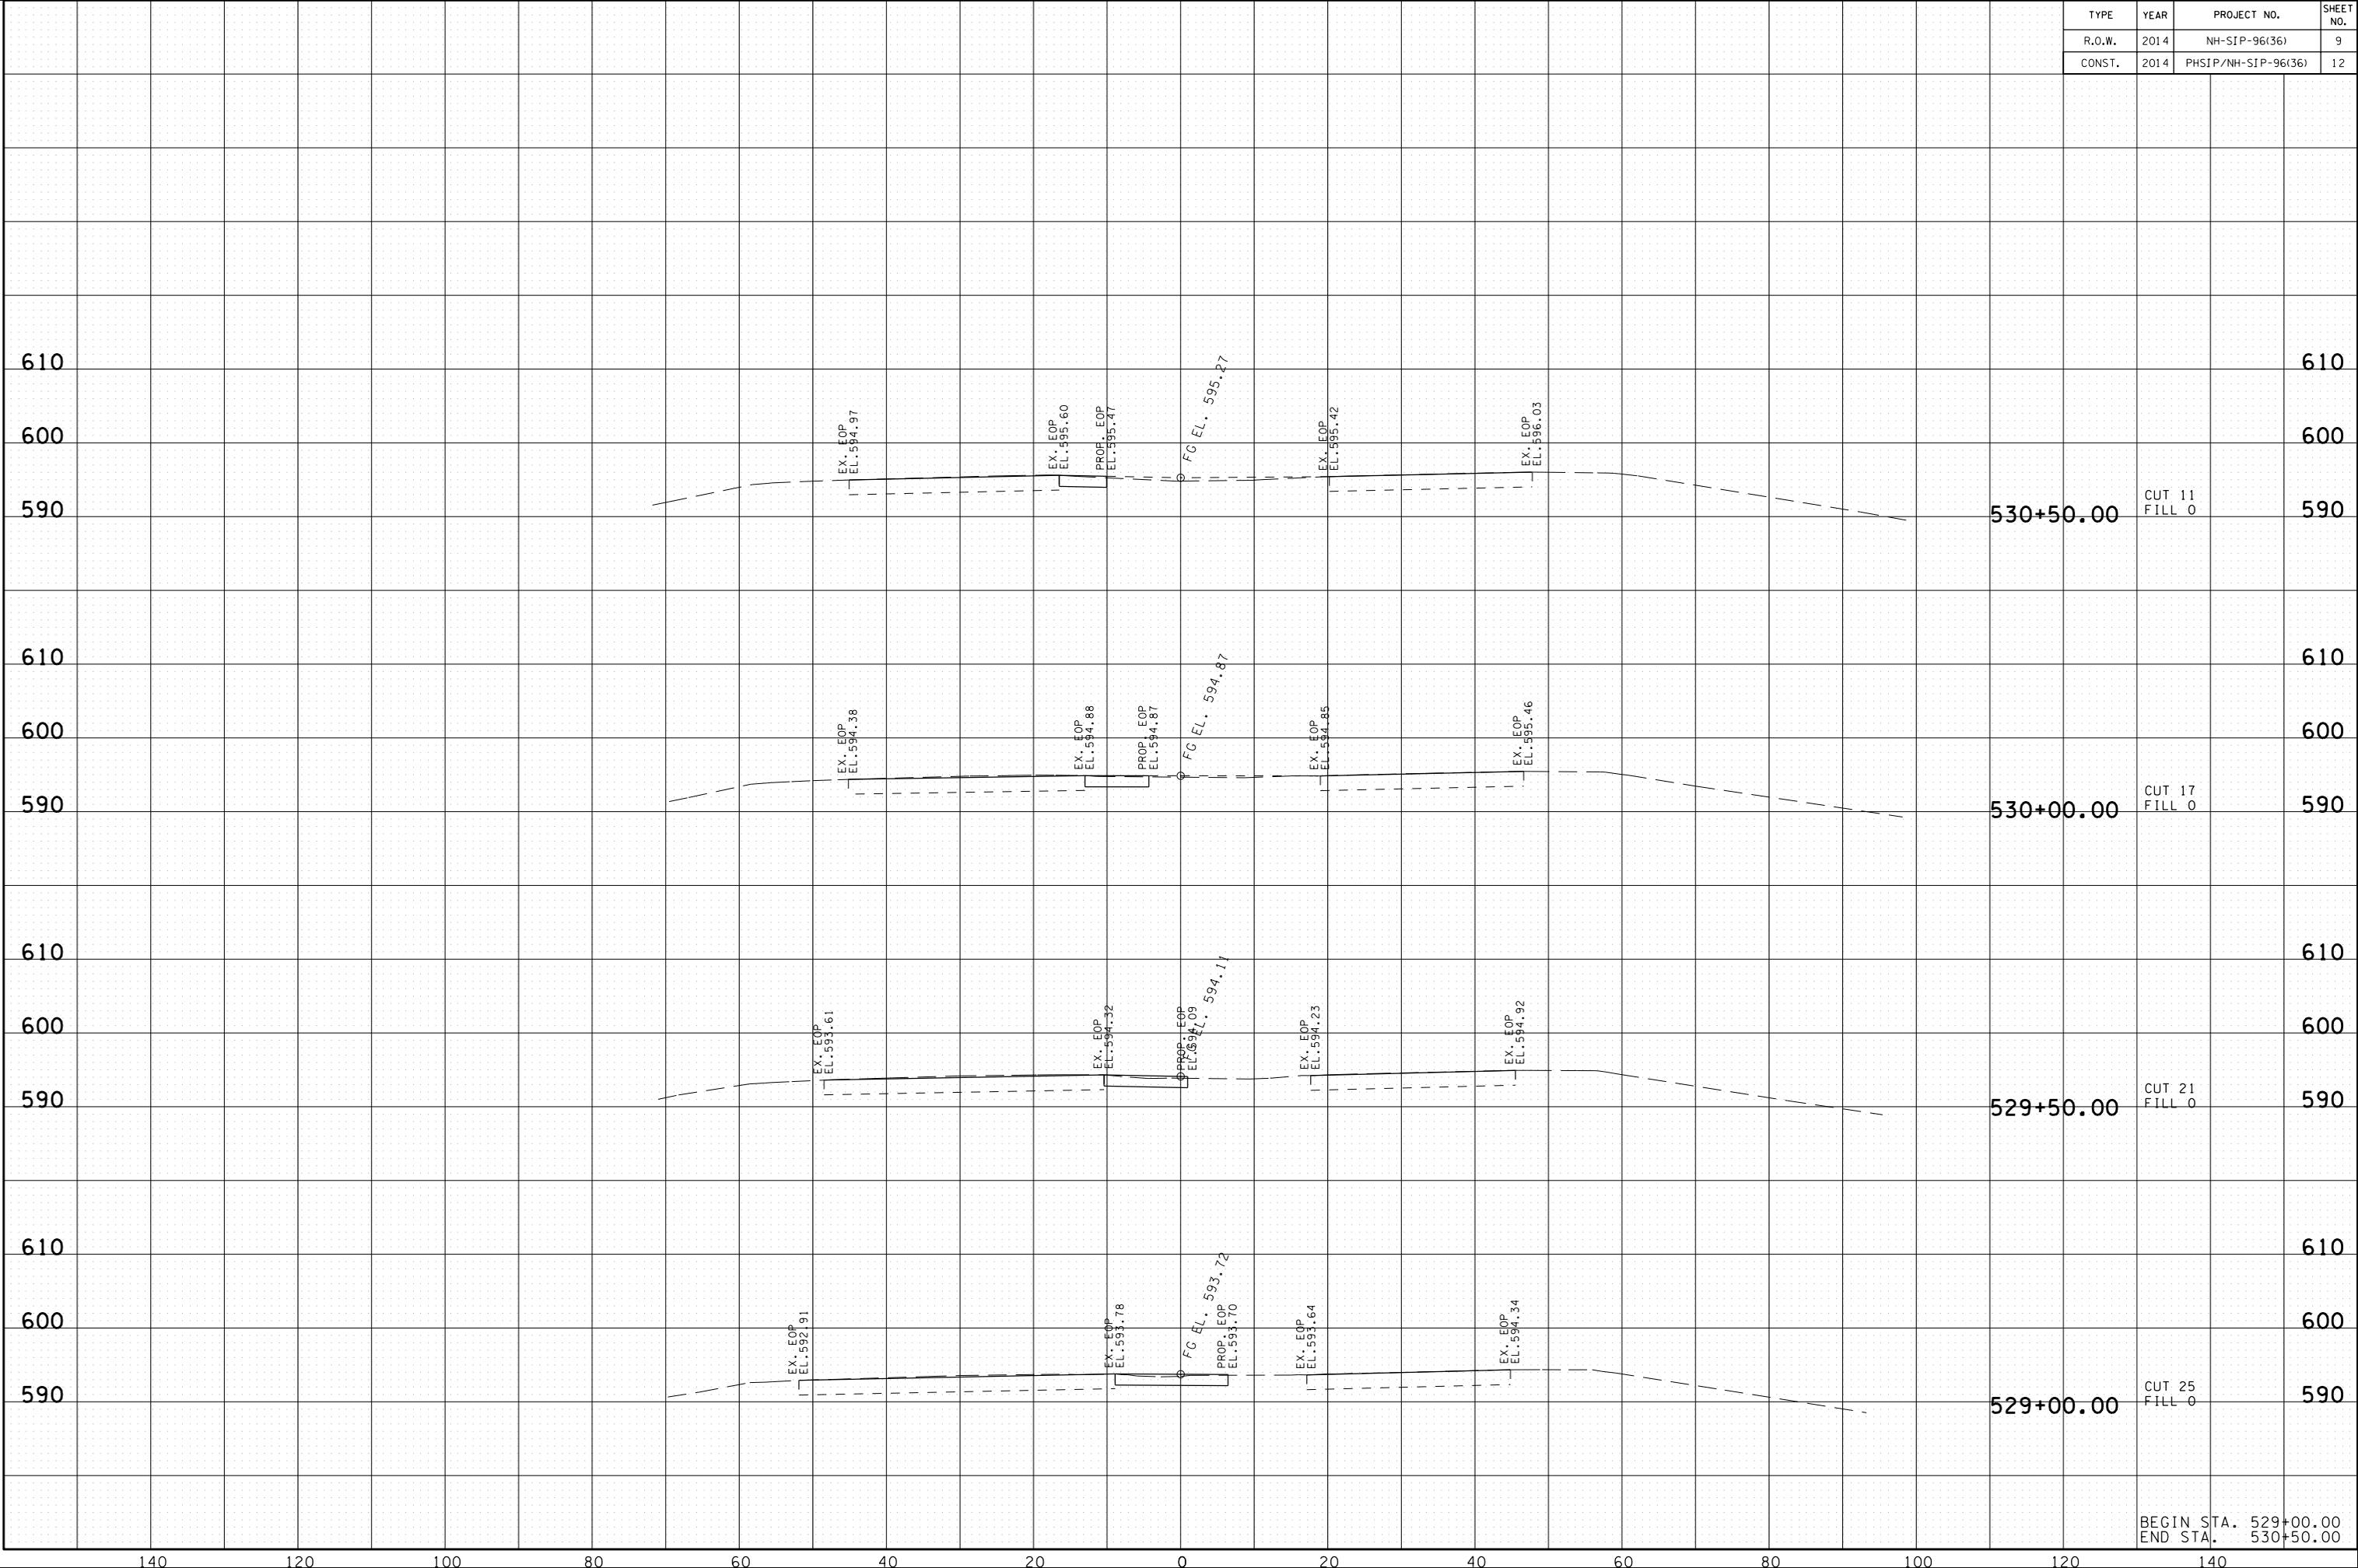
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BEGIN STA. 526+50.00
END STA. 528+50.00

TYPE	YEAR	PROJECT NO.	SHEET NO.
R.O.W.	2014	NH-SIP-96(36)	9
CONST.	2014	PHSIP/NH-SIP-96(36)	12

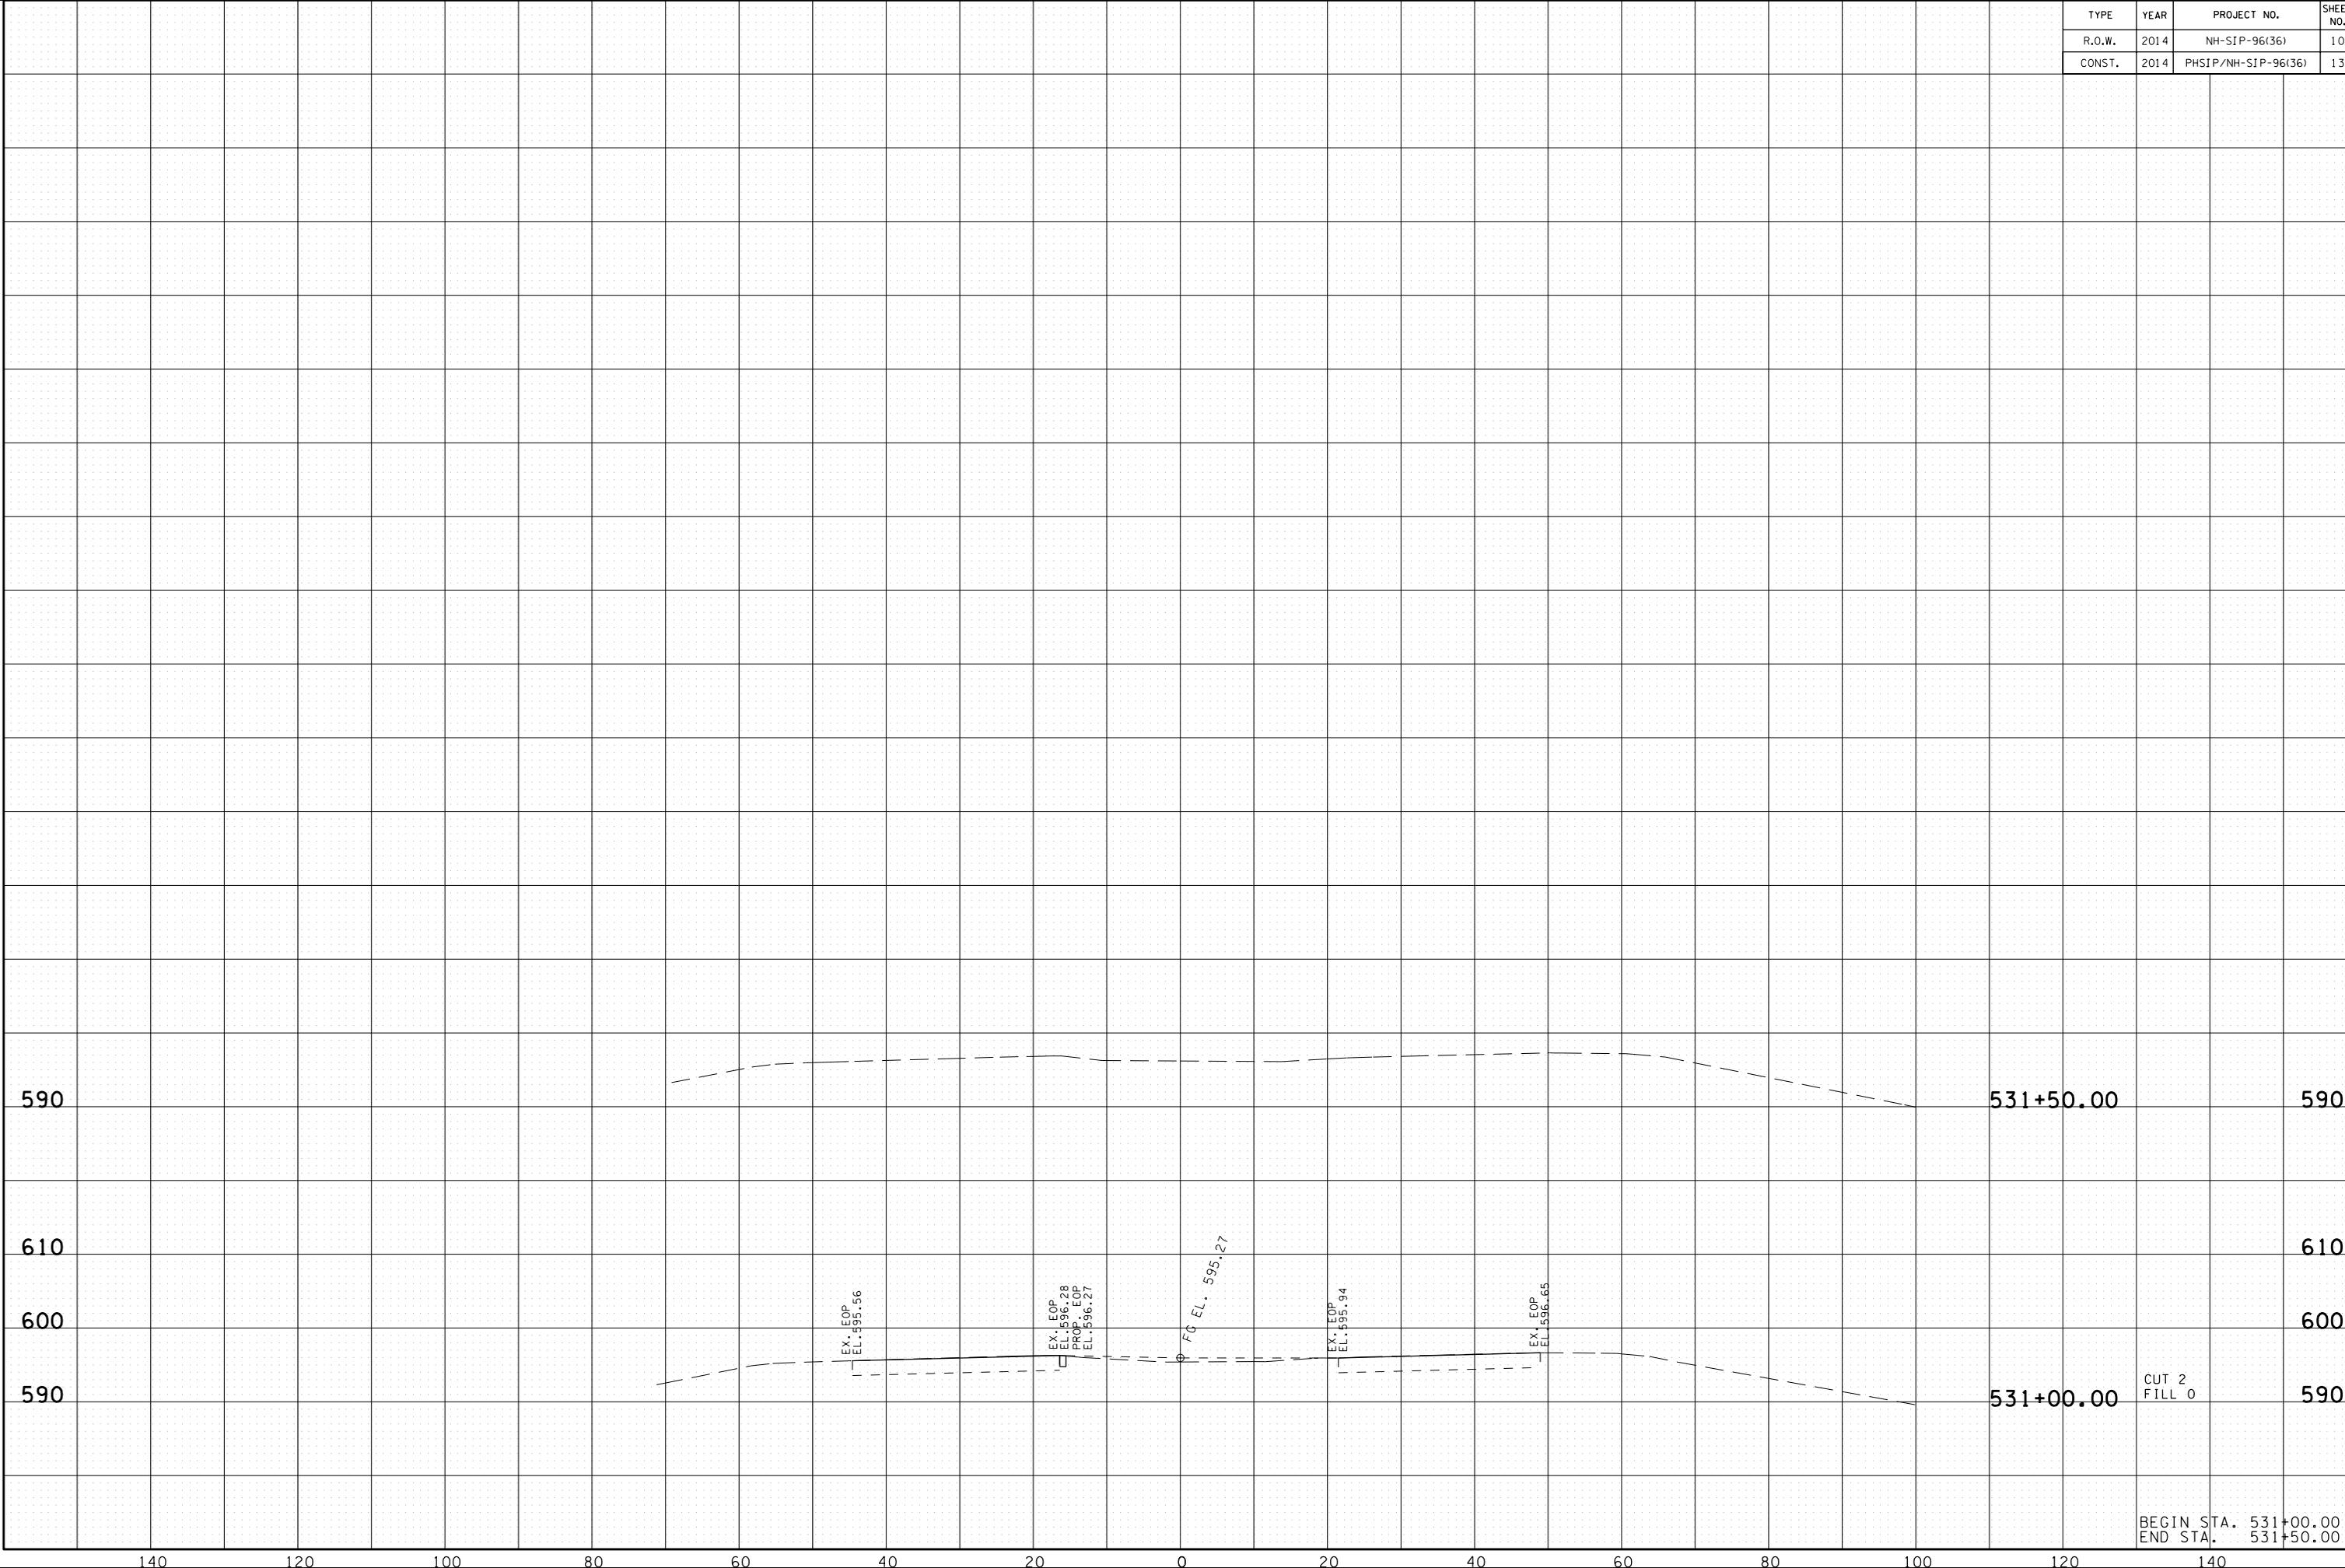
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BEGIN STA. 529+00.00
END STA. 530+50.00

TYPE	YEAR	PROJECT NO.	SHEET NO.
R.O.W.	2014	NH-SIP-96(36)	10
CONST.	2014	PHSIP/NH-SIP-96(36)	13

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BEGIN STA. 531+00.00
END STA. 531+50.00